# PRELIMINARY PLAN **ROSEWOOD VILLAGE**

SWQ SAWMILL PARKWAY & CLARK-SHAW ROAD POWELL, OH 43065 **DELAWARE COUNTY** LIBERTY TOWNSHIP 22-20-S

OWNER/DEVELOPER:
METRO DEVELOPMENT
CONTACT: JOE THOMAS
470 OLDE WORTHINGTON ROAD, SUITE 100
WESTERVILLE, OH 43082
PHONE:
EMAIL: JTHOMASJR@DRKMETRO.COM

**ENGINEER:** 

ms consultants, inc.
CONTACT: IAN AULTMAN, PE 2220 SCHROCK ROAD


# SURVEYOR:

ms consultants, inc.
CONTACT: CHAD SNOW, PS
2220 SCHROCK ROAD COLUMBUS, OH 43229 PHONE: 614-898-7100 EMAIL: CSNOW@MSCONSULTANTS.COM

# UTILITIES:

SANITARY SEWER: DELAWARE COUNTY REGIONAL SEWER DISTRICT CONTACT: KELLY THIEL SO CHANNING STREET DELAWARE, OH 43015 PHONE: 740-83-2245 EMAIL: KTHIEL@CO.DELAWARE.OH.US

ELECTRIC: AMERICAN ELECTRIC POWER (AEP) CONTACT: TRISTAN MULLANE 301 CLEVELAND AVE SW CANTON, OH 44702 PHONE: 330-438-7720 EMAIL: TTMULLANE@AEP.COM

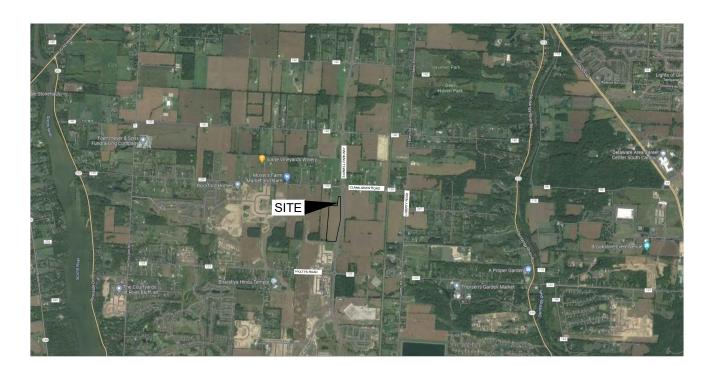

<b>VICINITY</b>	MAP
NTS	

SITE COORDINATES: **LATITUDE: 40.224117° N LONGITUDE: 83.096783° W** 

SITE DATA	
PARCEL AREA (LIBERTY TOWNSHIP)	19.40 AC
LIMITS OF DISTURBANCE	28.18 AC
EXISTING IMPERVIOUS AREA (LIBERTY TOWNSHIP)	0.00 AC
PROPOSED IMPERVIOUS AREA (LIBERTY TOWNSHIP)	8.22 AC
EXISTING PERVIOUS AREA (LIBERTY TOWNSHIP)	19.40 AC

**SHEET INDEX - CIVIL** 

C100

C101

C200-C201

C300

C301-C307

C400

C401-C407

C500

C501-C507

C600

C601-C607

11.18 AC

COVER

GENERAL NOTES

OVERALL SITE PLAN

SITE PLANS

GRADING PLANS

DRAINAGE PLANS

UTILITY PLANS

EXISTING CONDITIONS PLAN

OVERALL SITE GRADING PLAN

OVERALL DRAINAGE PLAN

OVERALL SITE UTILITY PLAN

PROPOSED PERVIOUS AREA (LIBERTY TOWNSHIP)

REVISION/DATE/DESCRIPTION

10/03/22 11/23/22



Suite 100 Westerville, OH 43082-8985, US



ms consultants, inc. engineers, architects, pla 2221 Schrock Road Columbus. Ohio 43229-1547 phone 614.898.7100 fax 614.898.7570

PROJECT

**ROSEWOOD** VILLAGE

SWQ SAWMILL PKWY & CLARK-SHAW RD POWELL, OH 43065

SHEET TITLE

**COVER SHEET** 

DRAWN BY:	TDB
CHECKED BY:	PGD/KPD
PROJECT NO:	26607

DRAWING



- A PRECONSTRUCTION CONFERENCE SHALL BE HELD AT THE COUNTY ENGINEER'S
  OFFICE BEFORE ANY WORK IS BEGUN. REPRESENTATIVES OF THE OWNER, DESIGN
  ENGINEER, AND CONTRACTOR SHALL BE IN ATTENDANCE. A SCHEDULE OF SEQUENCE
  OF EVENTS DURING CONSTRUCTION MUST BE SUBMITTED FOR REVIEW PRIOR TO THIS
  MEETING.
- PROOF SURVEYS ARE REQUIRED TO BE PERFORMED BY THE OWNER IN ORDER TO DEMONSTRATE CONCLUSIVELY THAT THE FACILITIES ARE CONSTRUCTED TO THE CAPACITY, ELEVATIONS, SLOPES, GRADES AND SIZES SHOWN ON THE APPROVED PLANS. SUCH SURVEYS SHALL BE CONDUCTED BY A REGISTERED PROFESSIONAL SURVEYOR, SHALL EMPLOY STANDARD TECHNOLOGY, AND SHALL PRODUCE AND FURNISH FIELD NOTES TO THE COUNTY ENGINEER FOR REVIEW AND RECORD PURPOSES. REDUCTION OF NOTES AND ANY PLOTTING INCESSARY TO MAKE NOTES INTERPRETABLE SHALL BE COMPLETED BY THE SURVEYOR PERFORMING THE PROOF SURVEY SHALL BE IN ADDITION TO, AND SEPARATE FROM, OTHER INSPECTIONS BY THE COUNTY ENGINEER. ALL DISCREPANCIES REVEALED IN THE AS-CONSTRUCTED FACILITIES BY THE PROOF SURVEY SHALL BE RECOFFICIED BY THE OWNER AND THE PROOF SURVEY SHALL BE APPROVED BY THE COUNTY ENGINEER. CONFORMANCE. THE PROOF SURVEY SHALL BE APPROVED BY THE COUNTY ENGINEER, N WRITING, PRIOR TO THE RELEASE OF THE BUILDING PERMITS.
- 4. BE ADVISED: A SUBSURFACE DRAINAGE SYSTEM MAY EXIST ON THIS SITE. THE CONTRACTOR SHALL MAINTAIN ALL EXISTING DRAIN PIPES OR TILES ENCOUNTERED IN THE FIELD AND, IF DAMAGED, REPAIR OR REPLACE THEM IMMEDIATELY WITH THE SAME SIZE AND QUALITY OF MATERIALS AS FOUND. ALL DRAINAGE TILES ENCOUNTERED IN THE FIELD SHALL BE CONNECTED TO THE STORM SEWER SYSTEM AT A STRUCTURE.
- THE CONTRACTOR SHALL NOTIFY THE COUNTY ENGINEER'S OFFICE FORTY EIGHT (48)
  HOURS PRIOR TO ANY CONSTRUCTION.
- THE CONTRACTOR'S BID SHALL BE COMPREHENSIVE AND INCLUDE ALL LABOR AND MATERIALS NECESSARY TO COMPLETE ALL IMPROVEMENTS ACCORDING TO THE ENGINEERING PLANS AND SPECIFICATIONS.
- THE CONTRACTOR SHALL LOCATE ALL UTILITIES OR UNDERGROUND STRUCTURES PRIOR TO CONSTRUCTION AND NOTIFY EACH RESPECTIVE UTILITY OWNER FORTY-EIGHT (48) HOURS PRIOR TO COMMENCEMENT OF CONSTRUCTION. CONTACT O.U.P.S. AT 1-800-362-2764.
- 8. IF A DISCREPANCY EXISTS BETWEEN THE PLANS AND SPECIFICATIONS, THE COUNTY ENGINEER AND THE OWNER'S ENGINEER SHALL BE NOTIFIED BEFORE WORK IS COMMENCED.
- IT IS THE RESPONSIBILITY OF THE CONTRACTOR TO EXERCISE SAFETY PRECAUTIONS AND TO PROVIDE ALL SAFETY EQUIPMENT TO SAFEGUARD WORKMEN AND ALL PERSONS ON OR NEAR THE WORK SITE.
- 10. THE CONTRACTOR SHALL EXAMINE THE WORK SITE AND SHALL SATISFY HIMSELF AS TO THE CHARACTER, QUALITY AND QUANTITIES OF WORK TO BE PERFORMED.
- HORIZONTAL AND VERTICAL LOCATION OF ALL EXISTING FEATURES WITHIN THIS SITE IS APPROXIMATE. IT IS THE RESPONSIBILITY OF THE CONTRACTOR TO FIELD VERIFY THE APPROXIMATE. IT IS THE RESPONSIBILITY OF THE CONTRACTOR TO FIELD VERHY LOCATION OF EXISTING FEATURES SHOWN ON PLANS, SUCH AS GAS LINES, WATER LINES AND FIELD TILE, TO PROPERLY EXECUTE THE WORK OF HIS CONTRACT. IT SHALL FURTHER BE THE RESPONSIBILITY OF THE CONTRACTOR TO EXERCISE DUE CAUTION AROUND EXISTING COMPLETED WORK ON THE SITE.
- 12. THE CONTRACTOR SHALL REPAIR OR REPLACE ANY AND ALL EXISTING WORK DAMAGED DURING OR DUE TO THE EXECUTION OF THIS CONTRACT AT HIS OWN EXPENSE. ALL SAID WORK IS TO BE REPAIRED OR REPLACED TO THE SATISFACTION OF THE OWNER AND THE COUNTY ENGINEER.
- 14. ALL MATERIAL DEEMED BY THE COUNTY ENGINEER SHALL BE REMOVED FROM THE PROPOSED RIGHT-OF-WAY, CONSTRUCTION LIMITS OR FOR ANY EXCAVATION FOR THE STORM SEWER SYSTEM. THE MATERIAL REMOVED INCLUDES, BUT IS NOT LIMITED TO, ORGANIC SOIL, TOPSOIL, VEGETATION, TREES, STUMPS, ROOTS OR EXCESSIVELY WET INGCANIC MATERIALS. THE MATERIAL SHALL BE REMOVED REGRATILESS OF THE AMOUNT OF EMBANKMENT TO BE CONSTRUCTED AND SHALL BE INCLUDED IN THE UNIT PRICE BID FOR ITEM 203, EXCAVATION.
- THE DELAWARE COUNTY ENGINEER OR HIS DESIGNATED REPRESENTATIVE SHALL OBSERVE AND APPROVE ALL SUB-BASE MATERIALS AND COMPACTION IN PUBLIC FILL ARFAS.
- NON-ORGANIC SITE SOILS ARE ACCEPTABLE AS USE FOR STRUCTURAL FILL PROVIDED THEY MEET ALL REQUIREMENTS OF C.O.C. ITEM 203. MOISTURE ADJUSTMENT MAY BE REQUIRED AND SHALL BE PREFORMED BY THE CONTRACTOR.
- 17. ANY LANDSCAPE FEATURES, SUCH AS TREES, FENCES, RETAINING WALLS, ETC. IN DRAINAGE EASEMENTS SHALL BE REVIEWED BY THE DELAWARE COUNTY SOIL AND WATER CONSERVANION DISTRICT (DOSWOD) AND THE DELAWARE COUNTY ENGINEER (DCEO) PRIOR TO INSTALLATION. THE DCSWCD AND DCEO WILL REVIEW THE PROPOSED IMPROVEMENTS OF ASSURE THAT THE IMPROVEMENTS WILL NOT INTERFERE WITH THE STORM WATER CONTROL FACILITIES.
- 18. THE CONTRACTOR SHALL REFERENCE ALL IRON PINS AND MONUMENTS BEFORE EXCAVATING AT OR NEAR SAID IRON PINS OR MONUMENTS. IF ANY PINS OR MONUMENTS ARE DESTROYED OR DAMAGED BY THE CONTRACTOR, THEY SHALL BE REPLACED BY A PROFESSIONAL LICENSED SURVEYOR OF OHIO AT THE COMPLETION OF THE PROJECT OR AT THE DIRECTION OF THE ECOUNTY ENGINEER AT NO EXPENSE TO THE OWNER. THE COST FOR THIS SHALL BE INCLUDED IN THE PRICE BID FOR VARIOUS ITEMS.
- ALL QUESTIONS SHALL BE DIRECTED TO THE DELAWARE COUNTY ENGINEER AT (740) 833-2400

## BACKFILLING FOR STORM SEWERS, CULVERTS AND UTILITIES

- UTILITY TRENCHES OUTSIDE THE RIGHT-OF-WAY SHALL BE BACKFILLED WITH OILS MEETING THE REQUIREMENTS OF ITEM 203 (100 PCF OR GREATER). THESE TRENCHES ARE TO BE COMPACTED IN ACCORDANCE TO STANDARD DRAWING DCED R-100 AT \( \sigma / \sigma / \circ \circ
- ALL UTILITY TRENCHES IN THE RIGHT-OF-WAY RUNNING PARALLEL TO THE EDGE PAVEMENT AND NOT OVER FIVE FEET (5') IN DEPTH SHALL BE BACKFILLED ACCORDING TO STANDARD DRAWING DECE R-100.
- ALL UTILITY TRENCHES UNDER ROAD PAVEMENT WITHIN THE R-O-W, STARTING AT A DISTANCE OF FIVE FEET (5) FROM THE EDGE OF THE PAVEMENT AND EXTENDING ONE FOOT (1') IN DISTANCE FOR EACH ONE FOOT (1') IN DEPTH SHALL BE BACKFILLE WITH COMPACTED GRANULAR MATERIALS PER STANDARD DRAWING DCED R-100 OR LOW STRENGTH MORTAR BACKFILL. ALSO, THE TOP OF ALL UTILITY CONDUITS SHALL BE LOCATED AT LEAST ONE FOOT BELOW THE UNDERDRANDS.
- ALL UTILITY TRENCHES OVER FIVE FEET (5') IN DEPTH, WITHIN THE R-O-W, WHICH RUN PARALLEL TO THE EDGE OF PAVEMENT OR THAT ARE IN THE ZONE OF INFLUENCE SHALL BE BACKFILLED AS PER STANDARD DRAWING DCED R-100.
- THE CONTRACTOR SHALL INCLUDE IN THE UNIT PRICE BID FOR UNDERGROUND UTILITY PIPE, ALL TRENCHING, BACKFILLING AS PER PLAN, AND THE REMOVAL AND DISPOSAL OF BRUSH, TREES, STUMPS, ETC. WITHIN THE AREA OF EXCAVATION OF THE TIERDCH.
- THE CONTRACTOR SHALL REFER TO THE UTILITY PLAN AND PROFILE SHEETS TO DETERMINE CRITICAL UTILITY CROSSINGS.
- IN PAVEMENT, SIDEWALK, AND UTILITY CROSSING AREAS THE BACKFILL SHAL BE COMPACTED GRANULAR MATERIAL PER C.O.C. ITEM 304, AND ALL OTHER REMAINING AREAS SHALL BE BACKFILLED PER C.O.C. ITEM 603.08.

- 8. THE CONTRACTOR SHALL RESTORE OFF—SITE CONSTRUCTION AREAS TO AN EQUAL OR BETTER CONDITION THAN THAT EXISTING PRIOR TO COMMENCEMENT OF CONSTRUCTION TO THE SATISFACTION OF THE COUNTY ENGINEER.
- 9. CASING PIPE REQUIRED WITHIN THE RIGHT-OF-WAY SHALL BE SDR 21 OR SCHEDULE 40 FOR NON-PRESSURIZED LINES AND C-900 (LESS THAN 12-INCHES) OR C-905 (GREATER THAN 12-INCHES) FOR PRESSURIZED LINES.

- THE CONTRACTOR SHALL INCLUDE IN THE UNIT PRICE BID FOR ITEM 603, ALL TRENCHING, EXCAVATION AND BACKFILLING PER STANDARD DRAWING DCED R-100, AND THE REMOVAL AND DISPOSAL OF BRUSH, TREES, STUMPS ETC. WITHIN THE AREA OF EXCAVATION OF THE TRENCH, UNLESS BID IN ITEM 203.
- THE PROPOSED ELEVATIONS AND LOCATIONS OF INLETS, CATCH BASINS, AND PIPES, AND THE ESTIMATED LENGTHS OF PIPES, MAY BE ADJUSTED BY THE ENGINEER DURING THE ENTIRE IMPROVEMENT OF THIS PROJECT. BASIS OF PAYMENT FOR POSSIBLE ADJUSTMENTS SHALL BE INCLUDED IN THE UNIT PRICE BID FOR VARIOUS STORM SEWERS TO BE ADJUSTED.
- 3. UNLESS OTHERWISE NOTED ON THE PLANS, ALL STORM SEWERS SHALL BE AS HEREAFTER SPECIFIED:
- b. STORM SEWERS LOCATED OUTSIDE OF THE RIGHT-OF-WAY SHALL BE TYPE CONDUIT (C.O.C. 706.02) OR HDPE COMPLYING WITH C.O.C. 720.12
- c. FOR ALL CONCRETE PIPE IN TYPE A, B, C AND D INSTALLATIONS, SEE THE CITY OF COLUMBUS SUPPLEMENTAL SPECIFICATIONS IN APPENDIX B OF THE DELAWARE COUNTY ENGINEERS DESIGN, CONSTRUCTION AND SURVEYING STANDARDS FOR THE MINIMUM CLASS OF PIPE THAT IS REQUIRED.
- 4. ALL TYPE "A", "B", AND "C" CONDUIT SHALL HAVE JOINTS, PER CITY OF COLUMBUS 901.15 AND SHALL USE TYPE C BITUMINOUS PIPE JOINT FILLER.
- BEDDING SHALL BE PROVIDED FOR ALL TYPE "A", "B", AND "C" CONDUIT PER DELAWARE COUNTY STANDARD DRAWINGS DCED S-149, DCED S-151, DCED S-152, DCED S-153 AND DCED S-155. GRANULAR BEDDING SHALL BE LIMITED TO CLEAN #8 OR #57 STONE AGGREGATE.
- ALL PIPES OUTSIDE THE RIGHT-OF-WAY SHALL HAVE A COVER OF 1.5 FEET MININUM. WHEREVER THIS IS NOT THE CASE, EMBANKMENT SHALL BE PLACED TO PROVIDE A MINIMUM COVER PRIOR TO THE INSTALLATION OF THE STORM
- OPENINGS SHALL BE PROVIDED IN THE DRAINAGE STRUCTURES TO ACCOMMODATE UNDERDRAIN OUTLETS. ANY CORING NECESSARY SHALL BE INCLUDED WITHIN THE COST OF THE UNDERDRAIN. UNDERDRAINS TO BE CONSTRUCTED IN ACCORDANCE WITH THE PLAN SPECIFICATIONS.

- EXCAVATION AND EMBANKMENT SHALL COMPLY WITH C.O.C. ITEM 203 AND DELAWARE COUNTY SUPPLEMENTAL SPECIFICATIONS.
- THE CONTRACTOR'S BID SHALL BE COMPREHENSIVE AND INCLUDE ALL LABOR AND EQUIPMENT TO COMPLETE ALL EXCAVATION, FILL AND GRADING IN ACCORDANCE WITH THE APPROVED ENGINEERING PLANS AND SPECIFICATIONS.
- EXCAVATION AND EMBANKMENT QUANTITIES DO NOT INCLUDE ANY PROVISION FOR UNDERCUTTING, FOOTINGS, OR UNSUITABLE MATERIAL.
- 4. AFTER THE TOPSOIL IS REMOVED, PROOFROLL THE PUBLIC MAINTAINED PAVEMENT AND BUILDING AREA SUBGRADES TO BE FILLED. SOFT AREAS SHOULD BE UNDERCUT AND STABULZED PRIOR TO FILLING OPERATIONS. RELATIVE DEPTH OF UNDERCUT WILL BE DETERMINED WHEN SOFT AREAS ARE DISCOVERED. THE DELAWARE COUNTY ENGINEER SHALL DETERMINE THE DEPTH AND EXTENT OF THE UNDERCUT.

### EROSION AND SEDIMENTATION CONTROL NOTES

PLEASE CONTACT THE DELAWARE COUNTY STORMWATER DEPARTMENT AT 740-833-2434 PRIOR TO STARTING CONSTRUCTION.

- SILTATION AND EROSION SHALL BE CONTROLLED BY MINIMIZING THE TIME THE SITE IS DENUDED BY TEMPORARY SEEDING, PERMANENT SEEDING, AND THE USE OF VARIOUS EROSION AND SEDIMENT CONTROL BEST MANAGEMENT PRACTICES (BMP's). THESE DEVICES ARE TO BE MAINTAINED THROUGHOUT THE CONSTRUCTION PHASE OF THIS PROJECT. ONCE THE SITE AREA HAS BEEN STABILIZED, BEST MANAGEMENT PRACTICES SHALL BE REMOVED WITH THE APPROVAL OF THE COUNTY ENGINEER.
- ALL MEASURES SHALL BE MAINTAINED AS REQUIRED BY THE DELAWARE COUNTY STORM WATER DEPARTMENT UNTIL ALL CONSTRUCTION UNDER THE CONTRACT HAS BEEN COMPLETED AND ACCEPTED BY THE COUNTY ENGINEER. MAINTENANCE SHALL INCLUDE ALL REPAIRS TO THOSE AREAS AND MEASURES DAMAGED BY EROSION, CONSTRUCTION EQUIPMENT, WEATHER, FIRE, AND/OR OTHER CAUSES INCLUDING "ACTS OF GOD."
- 3. THE TEMPORARY CONSTRUCTION ENTRANCES SHALL BE MAINTAINED IN A STATE THAT SHALL PREVENT TRACKING OR FLOW OF MUD ONTO THE PUBLIC RICHT-OF-WAY. THIS WILL BE ACCOMPLISHED BY USE OF A GRAVEL CONSTRUCTION ENTRANCE AND THE REPAIR AND/OR CLEANOUT OF ANY DEVICES USED TO TRAP THE SEDIMENT. ANY MAFERIALS SPILLED, DROPPED, OR TRACKED FROM THE CONSTRUCTION STE ONTO THE ROADWAYS OR INTO THE STORM SYSTEM MUST BE REMOVED IMMEDIATELY.
- SEDIMENT DEPOSITS IN SEDIMENT TRAPS SHALL BE REMOVED AND THE MEASURES RESTORED TO THEIR ORIGINAL DESIGN PRIOR TO THE SEDIMENT OBTAINING THE ONE-HALL DESIGN HEIGHT OF THE DEVICE. ALL SEDIMENT MATERIAL SHALL BE DISPOSED OF BY AN ACCEPTABLE MEANS. ANY SEDIMENT DEPOSITS REMAINING IN PLACE AFTER THE MEASURES ARE NO LONGER REQUIRED SHALL BE PREPARED TO CONFORM TO THE FINAL GRADING PLANS, SEEDDE AND MULCHAYS.
- 5. THE CONTRACTOR SHALL PLACE INLET PROTECTION FOR SEDIMENT CONTROL AT CATCH BASINS IMMEDIATELY AFTER THEIR CONSTRUCTION. COST FOR THIS WORK SHALL BE INCLUDED UNDER EROSION CONTROL. THE CONTRACTOR SHALL REMOVE INLET PROTECTION WHEN GRASS ESTABLISHMENT REACHES A MINIMUM OF 70% GROWTH DENSITY OVER THE ENTIRE DRAINAGE AREA FLOWING TO CATCH BASINS. THE COUNTY CHOINER SHALL DIRECT SEDIMENT CONTROL AT ALL CATCH BASINS IF REQUIRED.
- TOPSOIL SHALL BE REMOVED FROM PROPOSED RIGHT-OF WAY, MOUNDING AND EMBANKMENT AREAS PRIOR TO CONSTRUCTION OF PAVEMENT, MOUNDING, AND EMBANKMENT AREA. TOPSOIL SHALL BE STOCKPILED FOR RESPREADING.
- THE CONTRACTOR SHALL NOT DISTURB AREAS OUTSIDE CONSTRUCTION LIMITS UNLESS AUTHORIZED BY THE PROPERTY OWNER.
- 8. THE CONTRACTOR SHALL DISPOSE OF STREET, STOCKPILE, AND OVERLOT
- 9. THE SITE SHALL BE INSPECTED ON A WEEKLY BASIS FOR COMPLIANCE WITH THE SWPPP. FURTHERMORE, SEDIMENT CONTROL BMP'S SHALL BE INSPECTED IMMEDIATELY FOLLOWING EACH RAINFALL EVENT GREATER THAN ½ INCH AND AT LEAST DAILY DURING PERIODS OF PROLONGED RAINFALL. INSPECTION LOGS SHALL BE FURNISHED TO BELWARRE COUNTY FOR EACH INSPECTION.
- 10. CLOSE ATTENTION SHALL BE PAID TO THE PROPER INSTALLATION AND REPAIR OF PERIMETER CONTROLS TO PREVENT FAILURE.
- 11. NECESSARY REPAIRS TO BARRIERS OR REPLACEMENT OF PERIMETER CONTROLS SHALL BE ACCOMPLISHED PROMPTLY.

- 12. ANY SEDIMENT DEPOSITS REMAINING IN PLACE AFTER THE PERIMETER CONTROLS IS NO LONGER REQUIRED SHALL BE DRESSED TO CONFORM TO THE EXISTING GRADE, PREPARED AND SEEDED.
- 13. ADDITIONAL EROSION AND SEDIMENT CONTROL BMP's SHALL BE INSTALLED
- 14. THE CONSTRUCTION ENTRANCE, SEDIMENT BASINS (TEMPORARY AND/OR PERMANENT), AND PERIMETER CONTROLS SHALL BE INSTALLED AS THE FIRST STEP OF THE CONSTRUCTION SEQUENCE.
- 15. NO SITE WORK SHALL COMMENCE UNTIL THE EROSION AND SEDIMENT CONTROLS ARE APPROVED BY DELAWARE COUNTY.

- 1. DURING CONSTRUCTION AND PRIOR TO ACCEPTANCE OF ANY DURING CONSTRUCTION AND PRIOR TO ACCEPTANCE OF ANY IMPROVEMENTS IN THE PUBLIC R/W, THE OWNER/DEVELOPER SHALL REMOVE OR CAUSE TO BE REMOVED ALL REFUSE, RUBBIGH, UNUSED MATERIALS, EXCESS EARTH, FILL, ROCK, DEBRIS, AND FOREIGN MATTER FROM ALL PUBLIC RIGHTS OF WAY, AS WERE DEPOSITED, LEFT OR RESULTED FROM THE CONSTRUCTION OF IMPROVEMENTS OF ANY NATURE WITHIN THE DEVELOPMENT. SUCH REMOVAL SHALL TAKE PLACE WITHIN TWENTY-FOUR (24) HOURS AFTER BEING NOTIFED BY THE COUNTY ENGINEER THAT SUCH WORK IS REQUIRED, AND SHALL BE COMPLETED TO THE SATISFACTION OF THE COUNTY ENGINEER.
- 2. THIS WORK SHALL BE PERFORMED IN A MANNER WHICH PREVENTS EROSION AS WELL AS PREVENTS STORM WATER FROM ACCUMULATING OR PONDING ON THE SITE. THE WORK SHALL ALSO BE PERFORMED IN A MANNER THAT PREVENTS DISRUPTING OR IMPEDING SURFACE DRAINGE FROM ONSITE OR OFFSITE SOURCES AND PREVENTS ANY NEGATIVE EFFECTS ON ADJACENT PROPERTIES. A SIX—INCH OVERLAY OF TOPSOIL SHALL BE PROVIDED AND SHALL BE SEEDED PER DELAWARE COUNTY STANDARDS.

### SEEDING

- BASED ON CONSTRUCTION START-UP DATE AND CONTRACTOR'S SCHEDULE OF EVENTS, THE SEEDING MIXTURE AND SEDIMENT CONTROL MAY BE CHANGED TO COMPLY WITH DELAWARE COUNTY STANDARDS AND SUPPLEMENTAL SPECIFICATIONS, DUE TO A NON- GROWING SEASON AT THE TIME OF START-UP.
- THE CONTRACTOR SHALL APPLY TEMPORARY AND PERMANENT SEEDING, FERTILIZER, AND MULCHING TO THE SATISFACTION OF THE COUNTY ENGINEER.
- ALL SEEDING AND MULCHING SHALL BE BASED ON DELAWARE COUNTY STANDARDS AND SUPPLEMENTAL SPECIFICATIONS.

### RETENTION/DETENTION BASINS

- ANTI-SEEP COLLARS ARE REQUIRED FOR ALL RETENTION/DETENTION POND OUTLETS. A MINIMUM OF TWO COLLARS ARE REQUIRED. COLLARS MUST BE CONSTRUCTED (EXCAVATED) A MINIMUM OF 3.0° INTO UNDISTURBED SOIL ON ALL THREE SIDES. CLASS C CONCRETE PER CURRENT DELAMARE COUNTY SUPPLEMENTAL SPECIFICATIONS SHALL BE USED FOR REPLACEMENT OF THE EXCAVATED MATERIAL. THE COLLARS MUST BE A MINIMUM OF 8 INCHES THICK.
- 2. A CLAY CORE OF SUFFICIENT THICKNESS IS REQUIRED FOR ALL DETENTION AND RETENTION PONDS IN CUIT AREAS. THE COUNTY ENGINEER SHALL FIELD APPROVE THE CORE THICKNESS OR THE CONDITION OF THE EXISTING SOILS AS A SUBSTITUTE FOR A CLAY CORE (E.G., EXISTING CLAY MATERIAL).
- 3. TREES AND LANDSCAPING SHALL NOT BE PERMITTED ON EMBANKMENT

# DEL-CO WATER COMPANY GENERAL NOTES FOR WATER LINE CONSTRUCTION REVISED: JANUARY 17,2020

- GENERAL NOTES AS MODIFIED BY DEL-CO AND SHOWN ON THE APPROVED CONSTRUCTION DRAWNIGS SHALL SUPERSEDE THE REQUIREMENTS OF THE DEL-CO WATER COMPANY CONSTRUCTION STANDARDS MANUAL WHEREVER DISCREPANCIES OCCUR.
- STANDARD GENERAL NOTES:
   WATER LINE DESIGN, MATERIALS, AND INSTALLATION METHODS SHALL
  CONFORM TO APPLICABLE SECTIONS OF RECOMMENDED STANDARDS FOR
  WATER WORKS (TEN STATES STANDARDS), AMERICAN WATER WORKS
  ASSOCIATION (AWWA) STANDARDS, AND THE DEL-CO WATER COMPANY
  CONSTRUCTION STANDARDS WANUAL CONTRACTOR SHALL OBTAIN A COPY
  OF THE STANDARDS AND HAVE IN THEIR POSSESSION AT ALL TIMES DURING CONSTRUCTION. COORDINATE WORK WITH DEL-CO WATER (740)

- CONSTRUCTION STANDARDS MANUAL. CONTRACTOR SHALL OBTAIN A COPY OF THE STANDARDS AND HAVE IN THEIR POSSESSION AT ALL TIMES DURING CONSTRUCTION. COORDINATE WORK WITH DEL-CO. WATER (740) 5845-7746.

  DEL-CO. STANDARDS AND HAVE IN THEIR POSSESSION AT ALL TIMES DURING CONSTRUCTION. COORDINATE WORK WITH DEL-CO WATER (740) 5845-7746.

  DEL-CO. STANDARDS AND LOCATION OF THE PROPOSED WATER LINE IMPROVEMENTS. ALL TECHNICAL DETAILS REMAIN THE RESPONSIBILITY OF THE PROPOSED AND LOCATION OF THE PROPOSED WATER LINE IMPROVEMENTS. ALL TECHNICAL DETAILS REMAIN THE RESPONSIBILITY OF THE PROPOSED WATER LINE IMPROVEMENTS. ALL TECHNICAL DETAILS REMAIN THE RESPONSIBILITY OF THE PROPOSED WATER COMPANY TAKES NO RESPONSIBILITY. FINANCIAL OR OTHERWISE, REGARDING ERRORS IN THIS PLAN.

  C. CORRECTION OF ERROR OF AND THAT AFFECT DEL-CO. S WATER LINE PLANS, DIRECTLY OR NOIRIECTLY SHALL BE SUBMITTED TO, AND APPROVED BY DEL-CO WATER COMPANY PRIOR TO REVISIONS THAT AFFECT DEL-CO. S WATER LINE PLANS, DIRECTLY OR NOIRIECTLY SHALL BE SUBMITTED TO, AND APPROVED BY DEL-CO WATER AT THE COMPLETION OF THE WATERLINE INSTALLATION. THESE COORDINATES SHALL INCLUDE ALL MATERIALS, EQUIPMENT AND LABOR NECESSARY TO OBTAIN HORIZONTAL AND VERTICAL (NORTHINE, EASTING AND ELEVATION) SURVEY COORDINATES SHALL BE OBTAINED AT THE COMPLETION OF THE WATER MAIN IMPROVEMENTS. THE SURVEY COORDINATES SHALL BE OBTAINED AT THE COMPLETION OF THE WATER MAIN IMPROVEMENTS. THE SURVEY COORDINATES SHALL BE OBTAINED AT THE COMPLETION OF THE WATER MAIN IMPROVEMENTS. THE SURVEY COORDINATES SHALD BE OBTAINED AT THE COMPLETION OF THE WATER MAIN IMPROVEMENTS. THE SURVEY COORDINATES SHALL SHOULD SHALL INCLUDE ALL VALVES, TEES, FIRE HYDRANTS, BENDS, PLUGS, REDUCERS, TAPPED TEES, CURB STOPS, AIR RELEASES, ERROW THE MATER MAIN EMPREY 200 WHERE NO THINGS OR SERVICE SADDLES ARE TO BE INSTALLED.

  GENERAL SHALL BE REFERENCED TO THE APPLICABLE COUNTY ENGINEERS MONUMENTS AND SHALL BE REFERENCED TO THE APPLICABLE COUNTY ENGINEERS MONUMENTS AND SHALL BE BEASED ON THE NORTH AMERICAN DATM OF 1983 (NAD WI

- WATER LINE CONSTRUCTION:

  o. WATER LINES SHALL BE NSF 61 APPROVED, AND COMPLIANT WITH ASTM D2241 & OHIO EPA ENG-08-002 STANDARDS.
- USE THE FOLLOWING TYPE AND CLASS OF PIPE UNLESS OTHERWISE INDICATED ON THE DRAWINGS:

- USE THE FOLLOWING TYPE. AND CLASS OF PIPE UNLESS OTHERWISE INDICATED ON THE DRAWINGS:
  2—INCH WATER LINE PIPE: CLASS 200 SDR 21 YELOMINE PVC (RESTRAINED JOINT).
  4—INCH WATER LINE PIPE: CLASS 200 SDR 21 PVC.
  6—INCH WATER LINE PIPE: CLASS 200 SDR 21 PVC.
  18—INCH TO 12—INCH WATER LINE PIPE: CLASS 160 SDR 26 PVC.
  16—INCH AND LARGER WATER LINE PIPE: AWAW C151 CLASS 52 DIP.
  4—INCH PIPE AND LARGER USED FOR FIRE SERVICE: AWWA C900 DR 18 (150 PS) PVC.
  14. LI SIZES OF DEL-CO-OWNED WATER LINES USED ON MASTER METER PROJECTS: CLASS 200 SDR 21 PVC.
  14. LI SIZES OF DUCTULE IRON PIPE SHALL BE INSTALLED WITH POLYETHYLENE ENCASEMENT
  14. LI FITTINGS SHALL BE WECHANICAL JOINT CONFORMING TO AWWA C153.
  CROSSES SHALL NOT BE USED WITHOUT APPROVAL OF DEL-CO WATER COMPANY.
  14. LI VALVES SHALL BE MECHANICAL JOINT CONFORMING TO AWWA C153.
  CROSSES SHALL NOT BE USED WITHOUT APPROVAL OF DEL-CO WATER COMPANY.
  14. LI VALVES SHALL BE MECHANICAL JOINT CONFORMING TO AWWA WITH AIS 304 STAINLESS STEEL EXTERNAL HARDWARE. VALVES 12—INCH AND SWALLER SHALL BE RESILIENT-SEATED GATE VALVES PER AWWA C504.
  PROVIDE HEAVY-DUTY VALVE BOXES ON ALL HOT-TAPS AND AT VALVES LOCATED UNDER GRAVEL OR
- PROVIDE HEAVY-DUTY VALVE BOXES ON ALL HOT-TAPS AND AT VALVES LOCATED UNDER GRAVEL OR

- PROVIDE HEAVY-DUTY VALVE BOXES ON ALL HOT-TAPS AND AT VALVES LOCATED UNDER GRAVŁL ON PAVEMENT SURFACES.

  TOP OF VALVE BOX SHALL BE FLUSH WITH FINISHED GRADE IN PAVED AREAS, AND 4 INCHES ABOVE FINISHED GRADE IN NON-PAVED AREAS.
  MAINTAIN A MINIMUM 10-FOOT HORIZONTAL AND 1.5-FOOT VERTICAL SEPARATION BETWEEN
  WATER LINES AND SANITARY AND STORM SEWERS.

  ALL OTHER BURIED UTILITIES SHALL MAINTAIN A MINIMUM 5-FOOT HORIZONTAL SEPARATION, AND 2-FOOT VERTICAL SEPARATION FROM THE CENTERLINE OF WATER LINES AS FINALLY LAID AND CONSTRUCTED.

  PROVIDE CONCRETE THRUST BLOCKING FOR ALL FITTINGS, VALVES, ANCHOR TEES, AND HYDRANTS.
  BURY WATER LINES A MINIMUM DEPTH OF 48-INCHES TO THE TOP OF PIPE.

  1. ALL ENGINEERED FILL TO BE PLACED OVER OR UNDER DEL-CO WATER LINES SHALL BE IN PLACE PRIOR TO THE CONSTRUCTION OF THE WATER LINES.

  PLACE A 5-FOOT STEEL FENCE POST OR 4'X4' WOOD POST AT VALVES AND THE ENDS OF LINES. PAINT BLUE.

- INCLUSIONAL THE CONSTRUCTION OF THE CONTROLL O

- TEST.

  2. TESTER SHALL SEND A SIGNED REPORT TO DEL—CO WATER INSPECTION DEPARTMENT AFFIRMING ALL WIRE HAS CONTINUITY.

  3. CONTRACTOR SHALL REPAIR ALL DEFICIENCIES.

- WATER SERVICE CONSTRUCTION (BETWEEN MAIN LINE AND METER PIT):

  a. ALL WATER SERVICES SHALL BE CONSTRUCTED AND INSTALLED PER AWWA C800.
  b. FOR METERS 1-INICH AND SMALLER, USF 1-INICH CLASS 200 SOR 7. IRON PIPE SIZE (IPS) POLYETHYLENE PIPE.
  c. CONNECTIONS TO PUE PIES SHALL BE MADE WITH APPROVED TAPPING SADDLE AND
  CORPORATION STOP PER DEL-CO SUBDIVISION CONSTRUCTION STANDARDS MANUAL.
  d. CONNECTIONS TO DIP SHALL BE BY DIRECT TAP OR SADDLE AND APPROVED CORPORATION STOP PER DEL-CO
  SUBDIVISION ON STRUCTION STANDARDS MANUAL.
  SUBDIVISION ON STRUCTION STANDARDS MANUAL.
  SERVICE LINES OCATE WITH THE PERMALE RROW PIPE THERADS ON THE CUSTOMER SIDE AT THE END OF
  SERVICE LINES OCATE WITH THE WIND THE MAIN PIPE THE PIPE FEM EDGE OF SIDEWALK UNLESS OTHERWISE
  SERVICE LINES OCATE WITH THE PIPE SHALL BE MECCANICAL DIVINE CATE MAINES SETTEMBED.
- APPROVED OR DIFECTED BY DEL.—CO.

  ALL SERVICE LINE VALVES 15—INCH AND LARGER SHALL BE MECHANICAL JOINT GATE VALVES, RESTRAINED WITH DUCT-LUGS AND GALVANIZED ALL THREAD ROD, OR ANCHOR TEES WHERE APPLICABLE.

  MINIMUM DEPTH OF COVER SHALL BE 48 INCHES.

  H. PLACE A 5—FOOT STEEL FENCE POST OR 4X4\* WOOD POST AT THE ENDS OF ALL SERVICE LINES, PAINT BLUE.

  I. CONTRACTOR SHALL BE RESPONSIBLE FOR PROVIDING SPECIAL BACKFILL MATERIAL FOR ALL LINES, INCLUDING THOSE INSTALLED BY DEL—CO WATER COMPANY, WHERE REQUIRED BY THE COUNTY OR CITY ENGINEER.
- FIRE HYDRANTS:
  a. FIRE HYDRANTS SHALL CONFORM TO AWWA C502 FOR DRY BARREL HYDRANTS.

- G. FIRE HYDRANTS SHALL CONFORM TO AWWA C502 FOR DRY BARREL HYDRANTS.
  b. MAIN VALVE: 5.25-INCH COMPRESSION.
  c. NOZZLES:
  ii. THEADING: CONFORM TO NFPA NATIONAL STANDARD FIRE HOSE THREADS.
  ii. 4.5-INCH STEAMER. EXCEPT IN THE FOLLOWING LOCATIONS PROVIDE AN INTEGRAL STORZ CONNECTION.
  HARRINGTON HIRSSO OR EQUAL: BERKSHIRE, BERLIN, CONCORD, GENOA, KINGSTON, LIBERTY, ORANGE, PORTER, TRENTON, AND SCIOTO TOWNSHIPS; CITY OF POWELL; AND THE VILLAGES OF SUNBURY AND
- GALENA.

  iii. TWO 2.5-INCH HOSE CONNECTIONS.
- III. TWO Z.S-INCH RUSE CONNECTIONS.

  (INLET CONNECTION: 6-INCH MECHANICAL JOINT.

  6. OPERATING NUT: 1.5-INCH PENTAGON, TURN COUNTERCLOCKWSE TO OPEN.

  F. PLACEMENT OF HYDRANT 2 FEET FROM THE BACK OF CURB OR 8 FEET FROM THE EDGE. OF PAVEMENT ON NON-CURBED STREETS.

  9. EXTENSIONS AND PARTS: SHALL BE MANUFACTURED BY THE ORIGINAL EQUIPMENT MANUFACTURER.

  10. APPROVED MANUFACTURERS: MUELLER SUPER CENTURION 200, AMERICAN FLOW CONTROL B84-B, CLOW MEDIALIDN, M&H MODEL 129M, AWK NOSTALGIC 2780, OR KENNEDY QUARDIAN K8ID.

  1. PAINTING: REPAINT ALL HYDRANTS AFTER INSTALLATION PER DEL-CO SUBDIVISION CONSTRUCTION STANDARDS MANUAL SECTION 02731, PART 2.06.

  1. LIBERTY TOWNSHIP, POWELL, AND VILLAGE OF SUNBURY: SAFETY RED.

  11. OTHER TOWNSHIPS: SAFETY YELLOW.

  11. FIRE HYDRANTS LOCATED ON PRIVATE WATER LINES SHALL BE PAINTED INDUSTRIAL GREEN.

- 6. DISINFECT ALL WATER LINES IN ACCORDANCE WITH AWWA C651 AND DEL-CO SPECIFICATIONS.
- ALL PIPE INSTALLATION AND PRESSURE TESTING SHALL BE IN ACCORDANCE WITH AWWA C600 FOR DUCTILE IRON PIPE AND C605 FOR PLASTIC PIPE, AND DEL—CO SPECIFICATIONS.

  O. CONTRACTOR SHALL PROVIDE ALL EQUIPMENT NECESSARY TO PERFORM PRESSURE TEST.

  b. SCHEDULE TEST BETWEEN 8:00 AM AND 2:00 PM WEEKDAYS. NOTIFY DEL—CO 24 HOURS PRIOR TO TEST.
- 8. OBTAIN WRITTEN APPROVAL OF MATERIAL AND MANUFACTURERS LIST FROM DEL-CO WATER PRIOR TO BEGINNING CONSTRUCTION. PROVIDE CASING PIPE FOR ALL ROAD CROSSINGS UNLESS OTHERWISE APPROVED BY DEL—CO. CASING PIPE SHALL BE STEEL PIPE WITH 0.375—INCH WALL THICKNESS, OR PVC C900 FOR WATER LINES 12—INCH DIA. OR LESS. CASINGS FOR WATER LINES LARGER THAN 12—INCH DIA. MAY BE AWWA C905.
- EASEMENTS SHALL BE PROVIDED TO DEL-CO WATER BEFORE PERMISSION WILL BE GIVEN TO MAKE NEW SERVICE LINE CONNECTIONS.
- 11. CONNECTIONS TO EXISTING WATER LINES WILL BE MADE BY DEL-CO WATER AT THE CONTRACTOR'S EXPENSE OR PERFORMED BY CONTRACTOR'S WHO ARE APPROVED FOR MAKING CONNECTIONS. NOTIFIALL PROPERTY OWNERS, AND DEL-CO WATER, IN WRITING 48 HOURS BEFORE STARTING CONSTRUCT
- 12. CONTRACTOR SHALL EXCAVATE TO DETERMINE THE LOCATION AND DEPTH OF EXISTING WATER LINES WHEREVER COVER OVER THE WATER LINES IS BEING REDUCED. IF THE FINAL DEPTH OF THE WATERLINE WILL BE BELOW DEL—CO WATER STANDARDS, CONTRACTOR SHALL SUBMIT A RELOCATION PLAN FOR APPROVAL BY DEL—CO WATER, AND RELOCATE THE WATER LINE AT THEIR EXPENSE.
- 13. CONTRACTOR SHALL BE RESPONSIBLE FOR LOCATING AND PROTECTING THE WATER LINE PRIOR TO FINAL ACCEPTANCE BY DEL-CO WATER, AND REPAIRING ALL DAMAGES FROM CONSTRUCTION ACTIVITY.
- 14. DO NOT FILL NEW WATER LINES UNTIL APPROVED BY DEL-CO WATER CO. 15. BOOSTER PUMPS ARE NOT ALLOWED ON INDIVIDUAL SERVICES.
- 16. ALL WATER MAINS, INCLUDING THOSE NOT DESIGNED TO PROVIDE FIRE PROTECTION, SHALL BE SIZED FOLLOWING AN ANALYSIS BASED ON FLOW DEMANDS, AND PRESSURE REQUIREMENTS. THE SYSTEM SHALL BE DESIGNED TO MAINTAIN A MINIMUM PRESSURE OF 20 PSI AT GROUND LEVEL AT ALL POINTS IN THE DISTRIBUTION SYSTEM UNDER ALL DESIGNED FLOW CONDITIONS. NORMAL WORKING PRESSURE IN THE DISTRIBUTION SYSTEM SHALL NOT BE LESS THAN 35 FSI.

1. ALL SIGNS AND SIGN SUPPORTS SHALL CONFORM TO THE LATEST EDITION OF THE OMUTCD, ODOT STANDARD CONSTRUCTION DRAWINGS, AND THE 2016 ODOT CMS. IN ADDITION, ALL SIGNS LOCATED AT A COUNTY/TOWNSHIP INTERSECTION SHALL CONFORM TO STANDARD DRAWING DEED-R2185. ANY DEVIATION FROM THE ABOVE REQUIREMENTS FOR SIGNS AND/OR SUPPORTS WITHIN THE SUBDIVISIONS SHALL REQUIRE WRITTEN APPROVAL FROM THE TOWNSHIP. REVISION / DATE / DESCRIPTION

10/03/22 SUBMISSION 11/23/22

NOTICE

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PROJECT

**ROSEWOOD** VILLAGE SWQ SAWMILL PKWY & CLARK-SHAW RD

POWELL OH 43065


SHEET TITLE

**GENERAL** NOTES

> TDB DRAWN BY: PGD/KPD CHECKED BY:

> > 26607

PROJECT NO: DRAWING

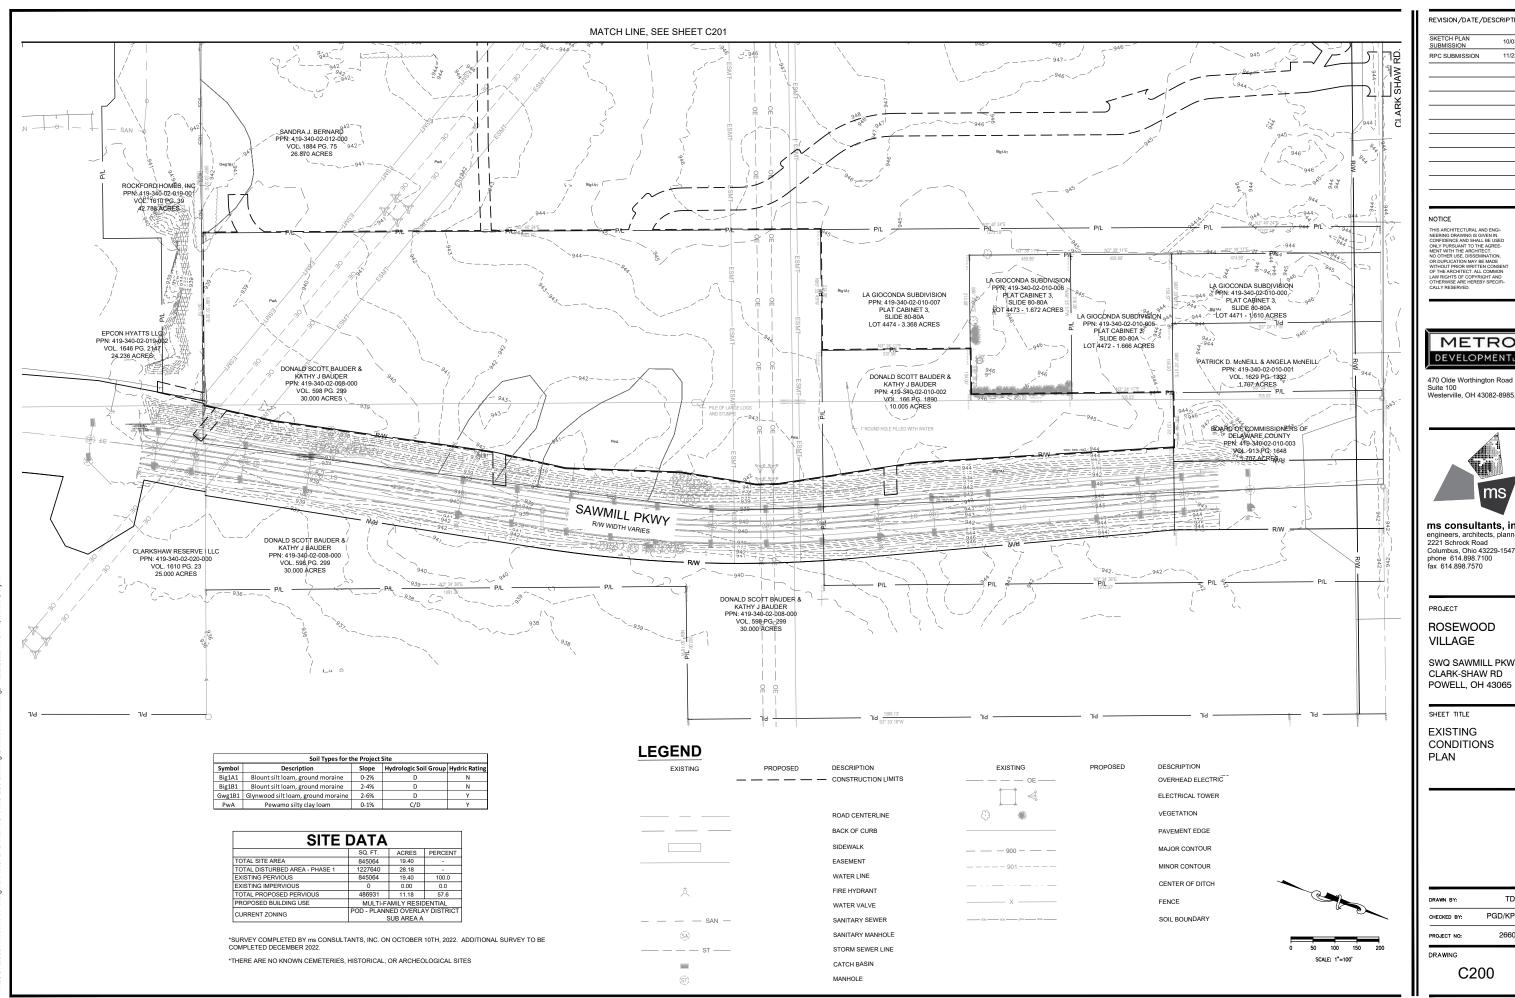

10/03/22 11/23/22



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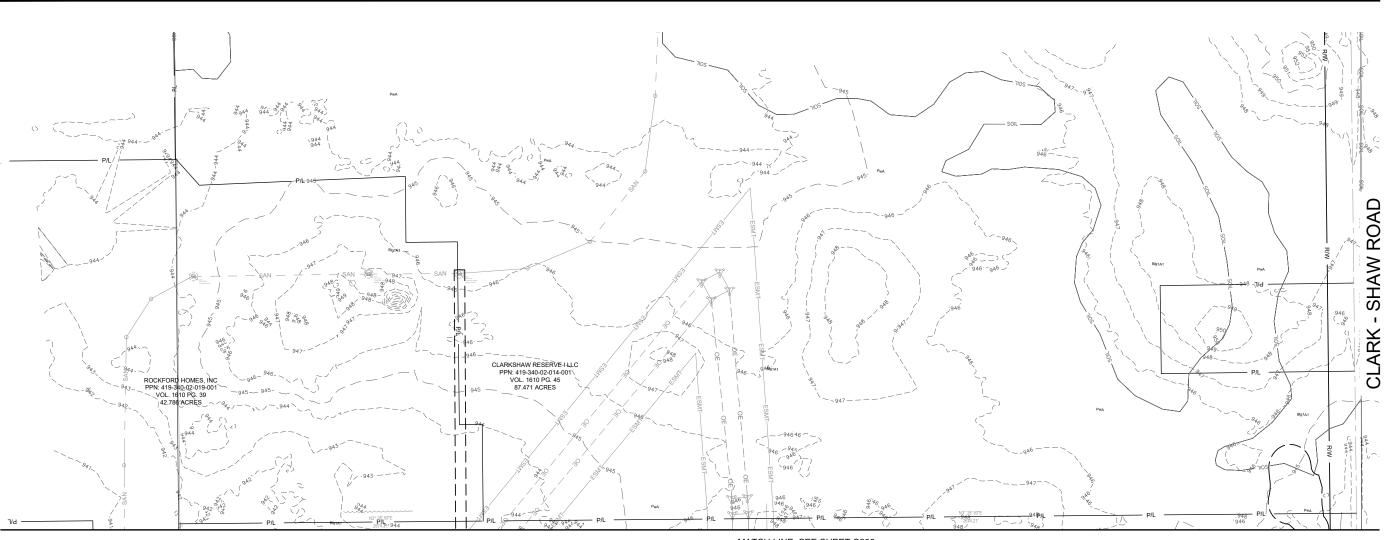
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**ROSEWOOD** 

SWQ SAWMILL PKWY & CLARK-SHAW RD POWELL, OH 43065

CONDITIONS

TDB PGD/KPD 26607



MATCH LINE, SEE SHEET C200

	Soil Types for t	he Project:	Site	
Symbol	Description	Slope	Hydrologic Soil Group	<b>Hydric Rating</b>
Big1A1	Blount silt loam, ground moraine	0-2%	D	N
Big1B1	Blount silt loam, ground moraine	2-4%	D	N
Gwg1B1	Glynwood silt loam, ground moraine	2-6%	D	Υ
PwA	Pewamo silty clay loam	0-1%	C/D	Υ

SITE	DATA		
	SQ. FT.	ACRES	PERCENT
TOTAL SITE AREA	845064	19.40	-
TOTAL DISTURBED AREA - PHASE 1	1227640	28.18	-
EXISTING PERVIOUS	845064	19.40	100.0
EXISTING IMPERVIOUS	0	0.00	0.0
TOTAL PROPOSED PERVIOUS	486931	11.18	57.6
PROPOSED BUILDING USE	MULTI-FA	MILY RESID	DENTIAL
CURRENT ZONING	POD - PLANN	IED OVERLA	Y DISTRIC

\*SURVEY COMPLETED BY ms CONSULTANTS, INC. ON OCTOBER 10TH, 2022. ADDITIONAL SURVEY TO BE COMPLETED DECEMBER 2022.

\*THERE ARE NO KNOWN CEMETERIES, HISTORICAL, OR ARCHEOLOGICAL SITES

LEGEND					
EXISTING	PROPOSED	DESCRIPTION			
_		<ul> <li>CONSTRUCTION LIMITS</li> </ul>	OE	OVERHEAD ELECTRIC	
				ELECTRICAL TOWER	
		ROAD CENTERLINE	₩	VEGETATION	
		BACK OF CURB		PAVEMENT EDGE	
		SIDEWALK	900	MAJOR CONTOUR	
		EASEMENT	901	MINOR CONTOUR	
		WATER LINE			
<b></b>		FIRE HYDRANT		CENTER OF DITCH	~~
/\		WATER VALVE	х	FENCE	
SAN _		SANITARY SEWER	SOI SOI SOI	SOIL BOUNDARY	
(SA)		SANITARY MANHOLE			
st		STORM SEWER LINE			0 50 100 150 200
9000		CATCH BASIN			SCALE: 1"=100'
(\$1)		MANHOLE			

REVISION/DATE/DI	ESCRIPTION
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PROJECT

ROSEWOOD VILLAGE

SWQ SAWMILL PKWY & CLARK-SHAW RD POWELL, OH 43065


SHEET TITLE

EXISTING CONDITIONS PLAN

DRAWN BY: TDB
CHECKED BY: PGD/KPD
PROJECT NO: 26607
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C201

N:\03\67\26607 Rosewood Village\Docs\CAD\Civi\DWG-Set\C-200 Existing Cond

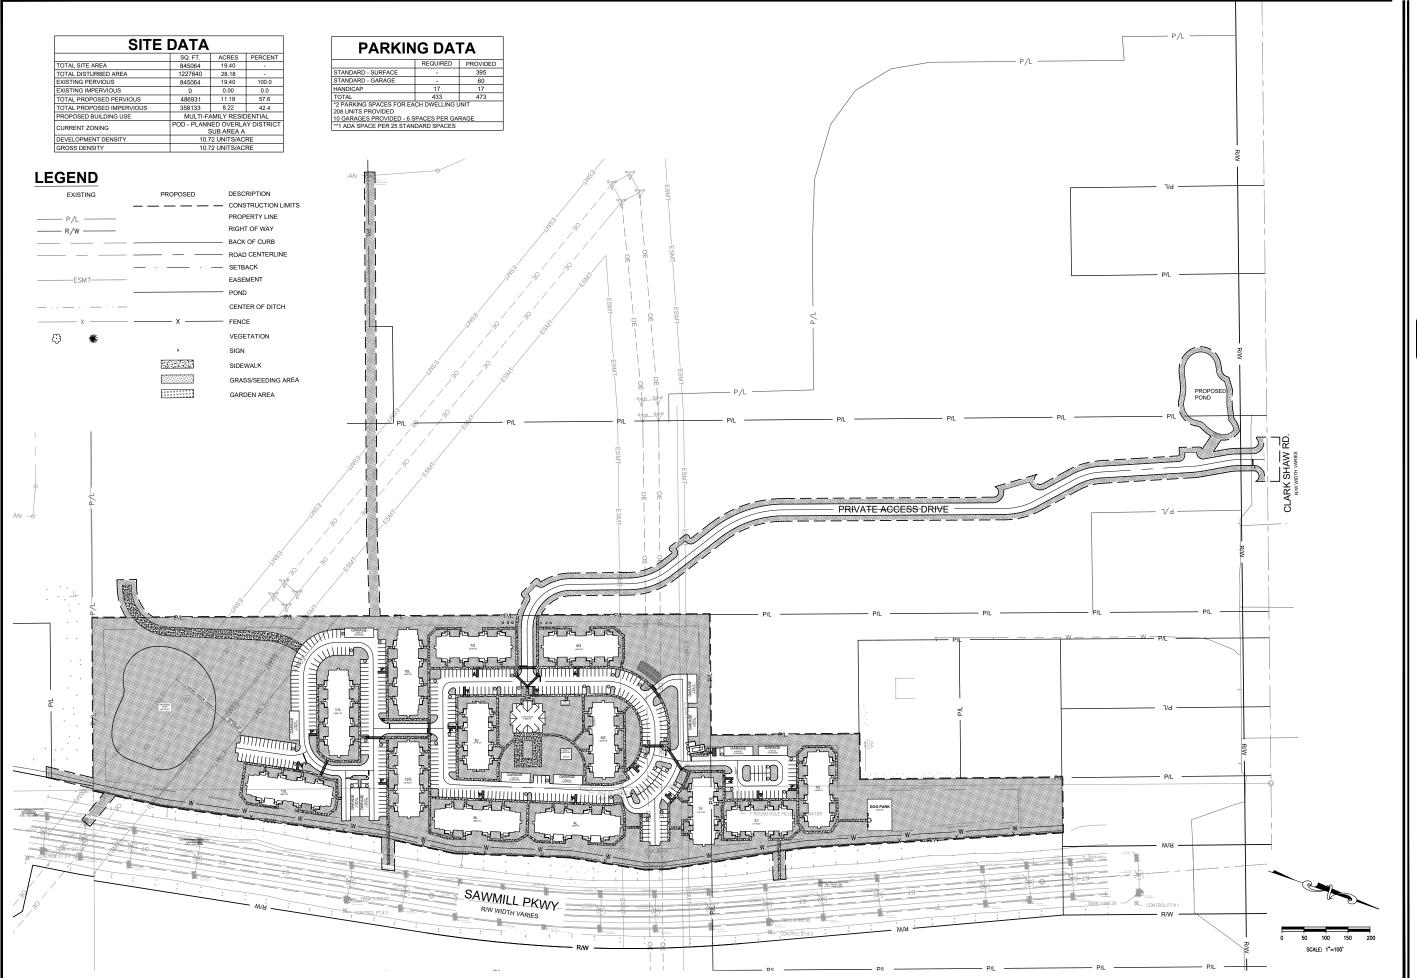

 SKETCH PLAN
 10/03/22

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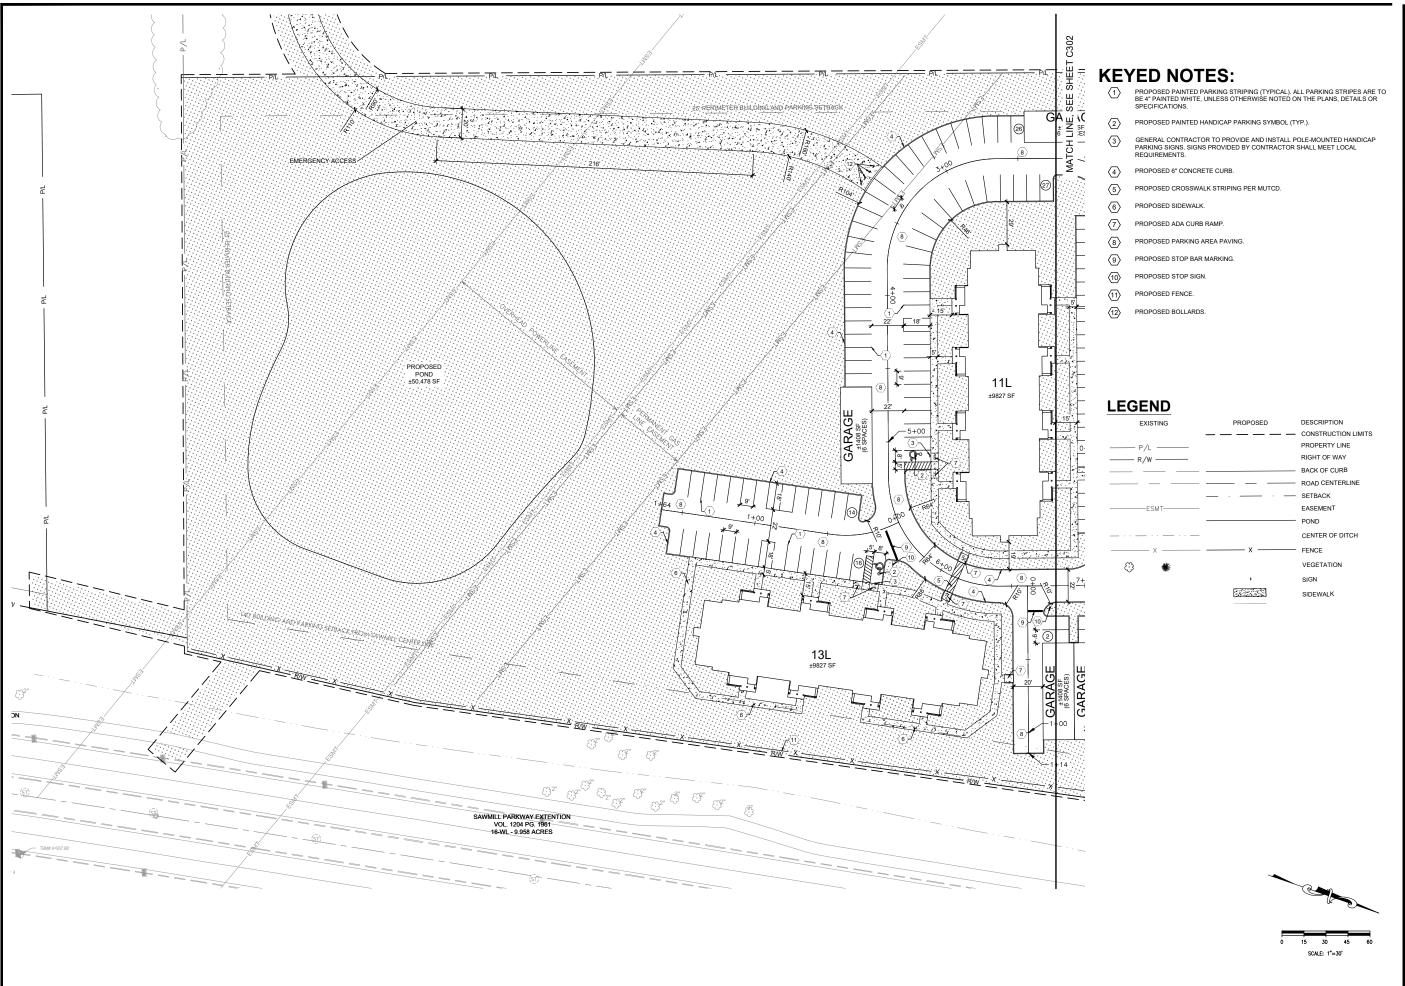
OVERALL SITE PLAN

DRAWN BY: TDB

CHECKED BY: PGD/KPD

PROJECT NO: 26607

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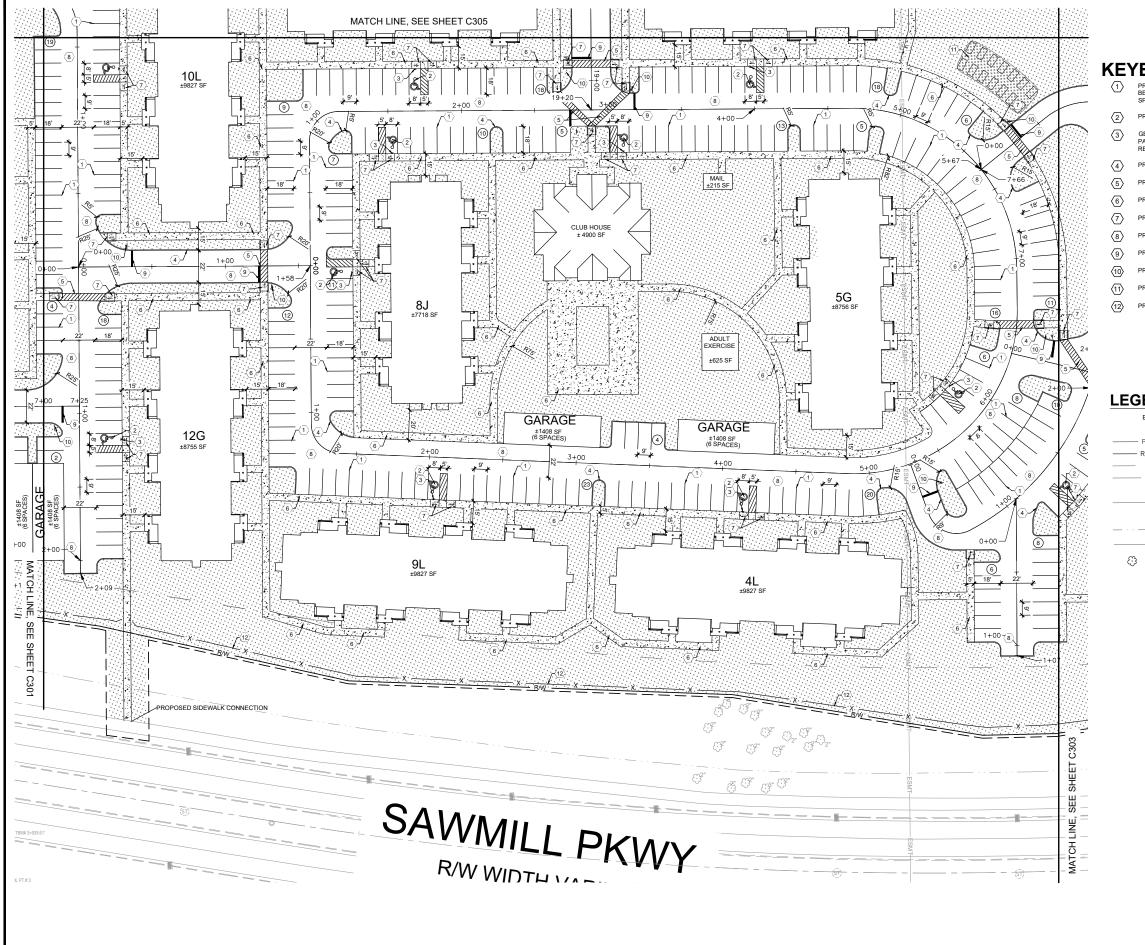
SWQ SAWMILL PKWY & CLARK-SHAW RD POWELL, OH 43065

SHEET TITLE

SITE PLAN 1




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CHECKED BY: PGD/KPD
PROJECT NO: 26607
DRAWING



# **KEYED NOTES:**

- PROPOSED PAINTED PARKING STRIPING (TYPICAL), ALL PARKING STRIPES ARE TO BE 4" PAINTED WHITE, UNLESS OTHERWISE NOTED ON THE PLANS, DETAILS OR SPECIFICATIONS.
- PROPOSED PAINTED HANDICAP PARKING SYMBOL (TYP.).
- GENERAL CONTRACTOR TO PROVIDE AND INSTALL POLE-MOUNTED HANDICAP PARKING SIGNS: SIGNS PROVIDED BY CONTRACTOR SHALL MEET LOCAL REQUIREMENTS.
- PROPOSED 6" CONCRETE CURB.
- PROPOSED CROSSWALK STRIPING PER MUTCD.
- PROPOSED SIDEWALK.
- PROPOSED ADA CURB RAMP
- PROPOSED PARKING AREA PAVING
- PROPOSED STOP BAR MARKING.
- PROPOSED STOP SIGN.
- PROPOSED GARDEN AREA.
- PROPOSED FENCE.

# **LEGEND**

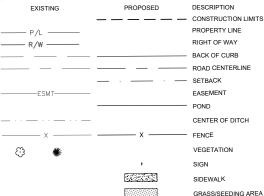

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**ROSEWOOD** VILLAGE

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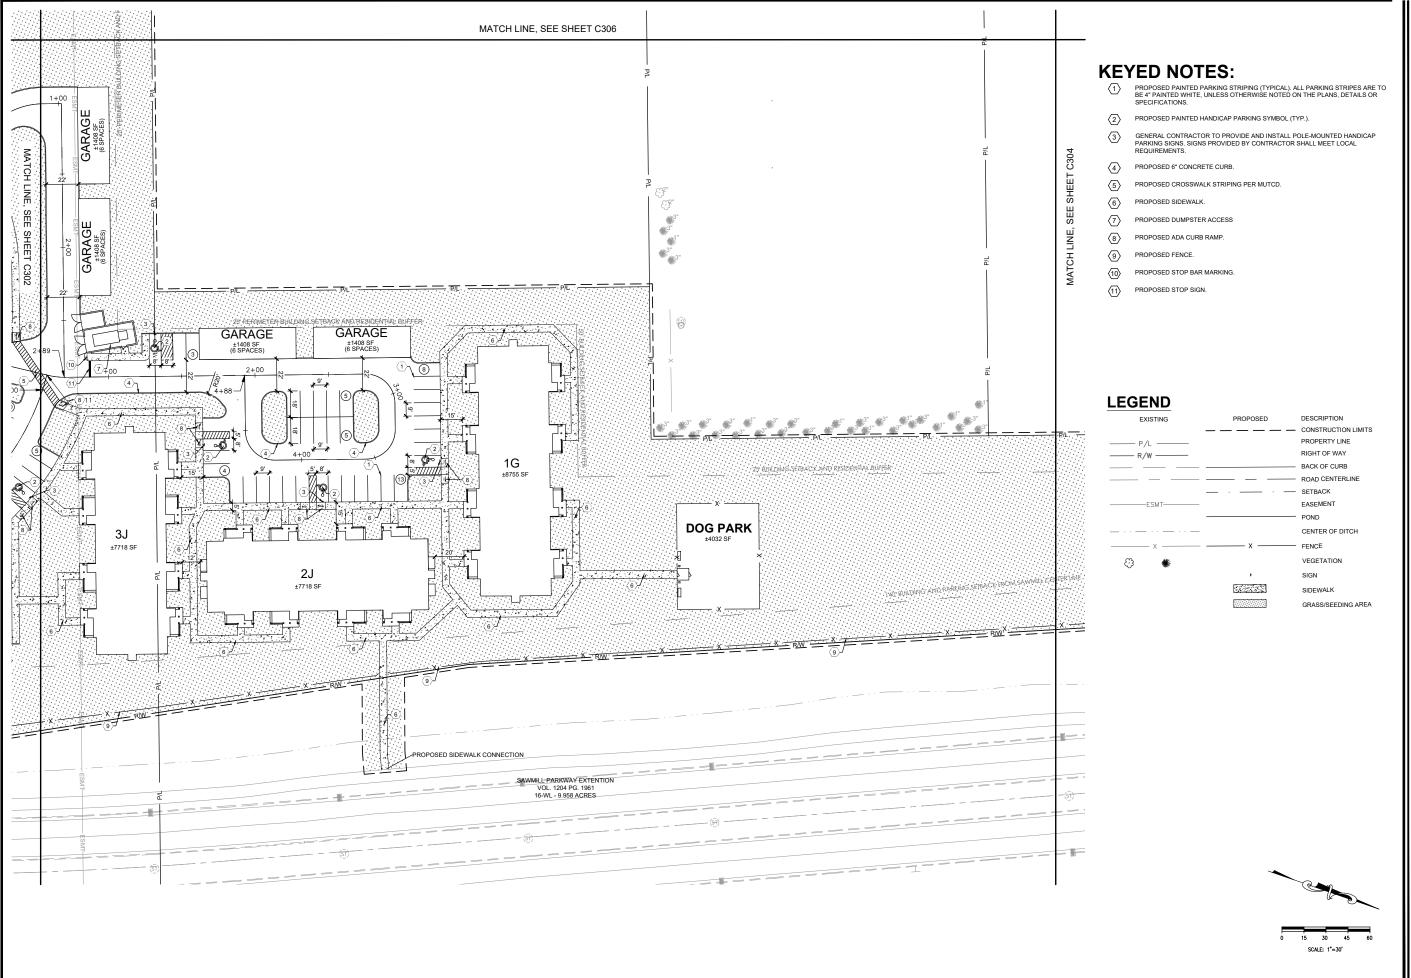
SHEET TITLE

SITE PLAN 2



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SCALE: 1"=30"



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SHEET TITLE

SITE PLAN 3




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DRAWING

KAWING



# **KEYED NOTES:**

1 PROPOSED FENCE.
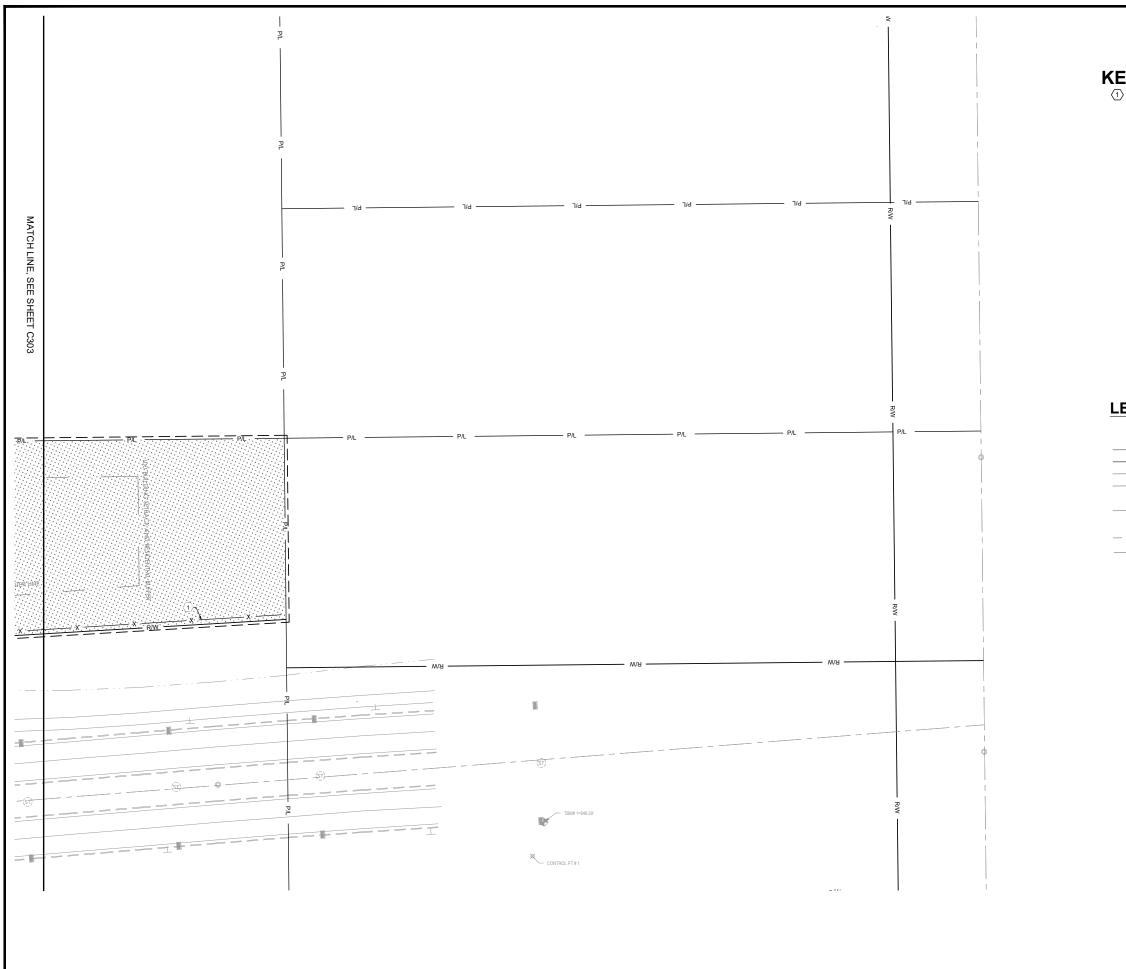
# **LEGEND**

EXISTING	PROPOSED	DESCRIPTION
		CONSTRUCTION LIMITS
—— P/L ——		PROPERTY LINE
—— P/L ——— —— R/W ———		RIGHT OF WAY
		BACK OF CURB
		ROAD CENTERLINE
	_ · _ · _	SETBACK
ESMT		EASEMENT
		POND
		CENTER OF DITCH
x	x	FENCE
₽ **		VEGETATION
	•	SIGN
	55.55	SIDEWALK
	W	GRASS/SEEDING AREA

REVISION/DATE/DESCRIPTION

 SKETCH PLAN
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SHEET TITLE

SITE PLAN 4




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DRAWING

SCALE: 1"=30'



	REVISION/DATE/DESCRIPTION
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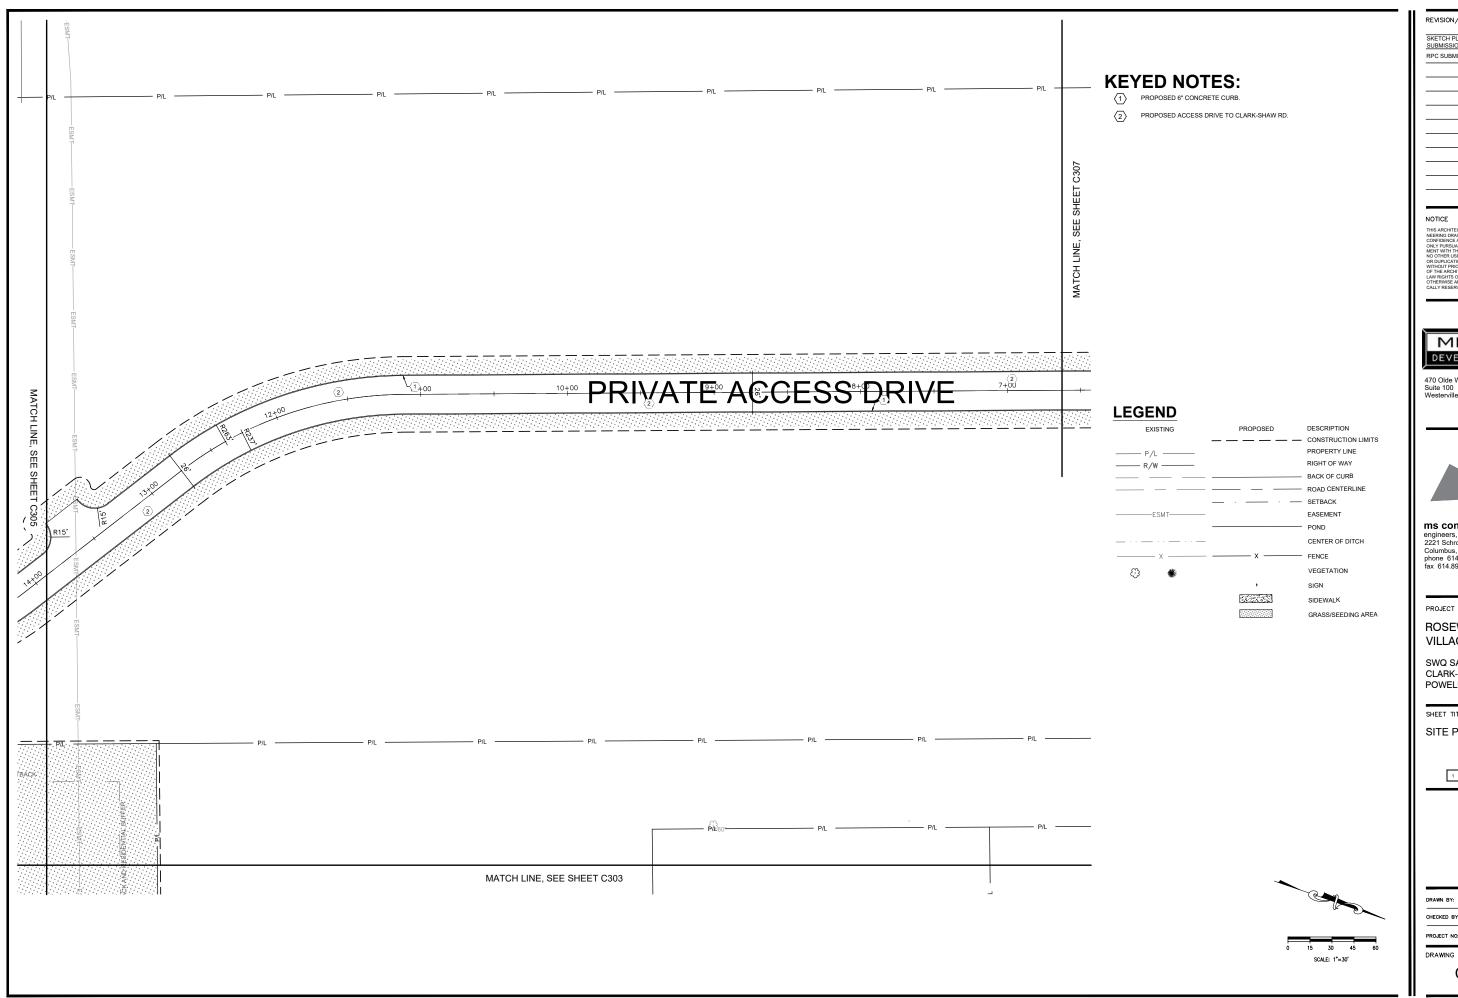
SHEET TITLE

SITE PLAN 5

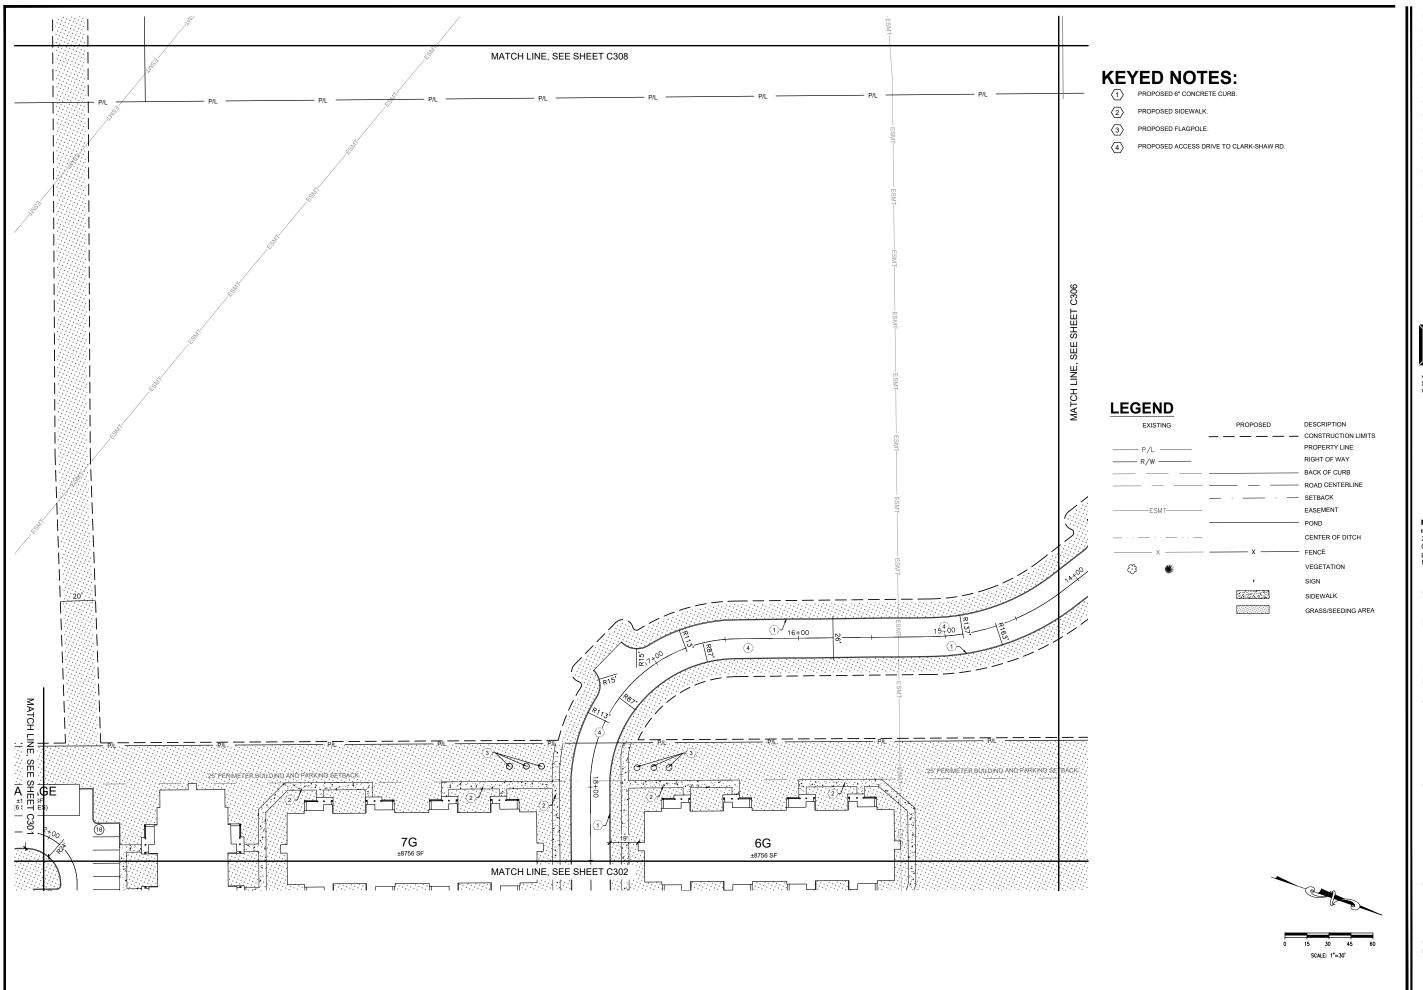

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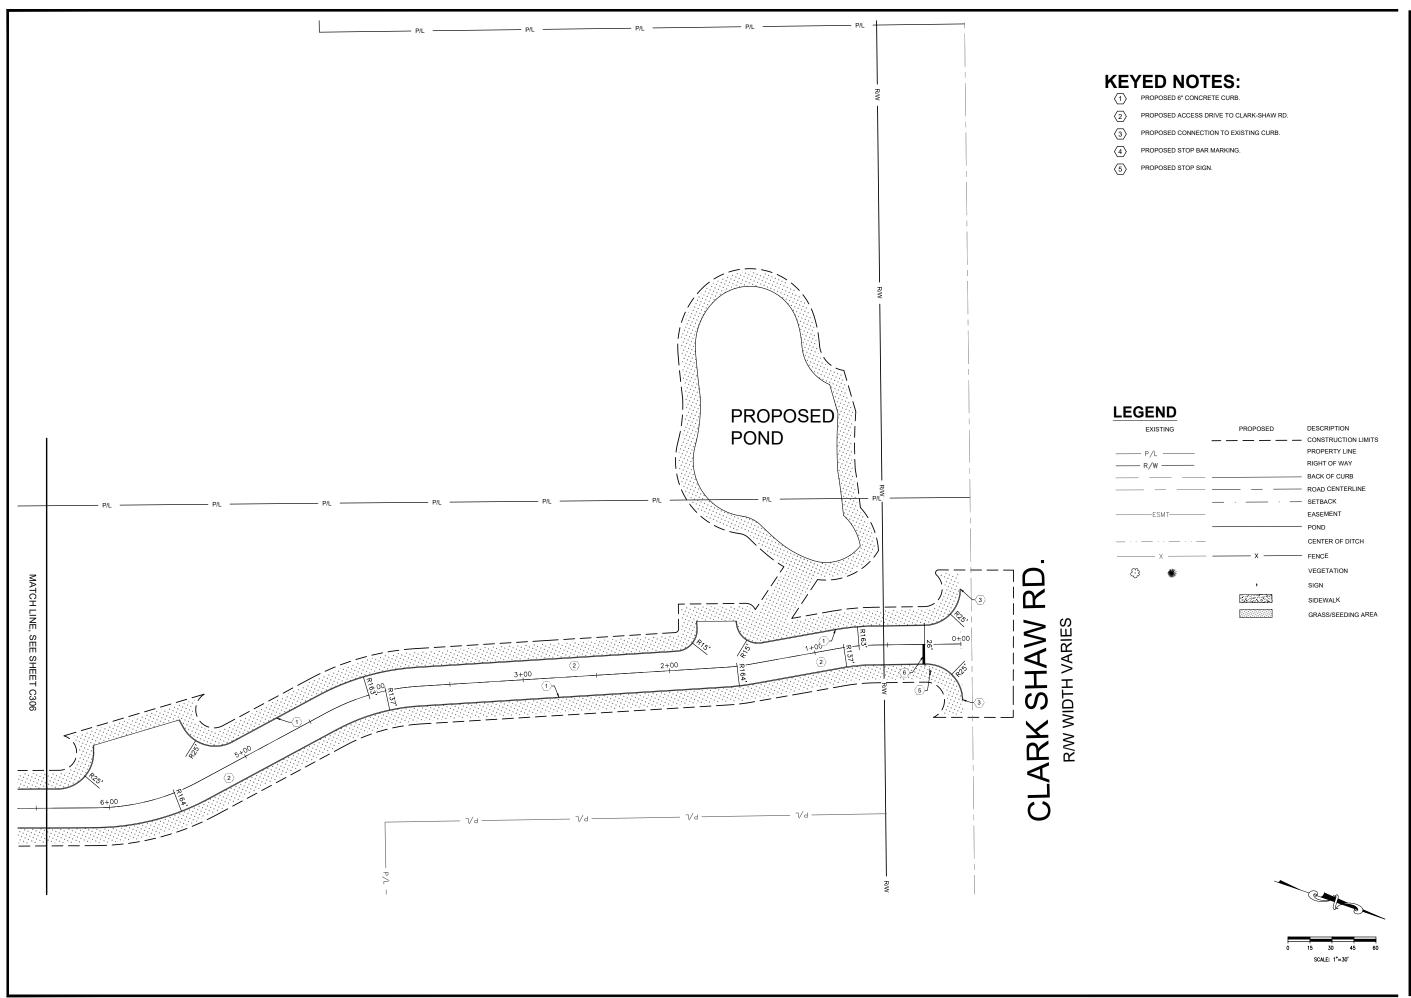
SHEET TITLE

SITE PLAN 6



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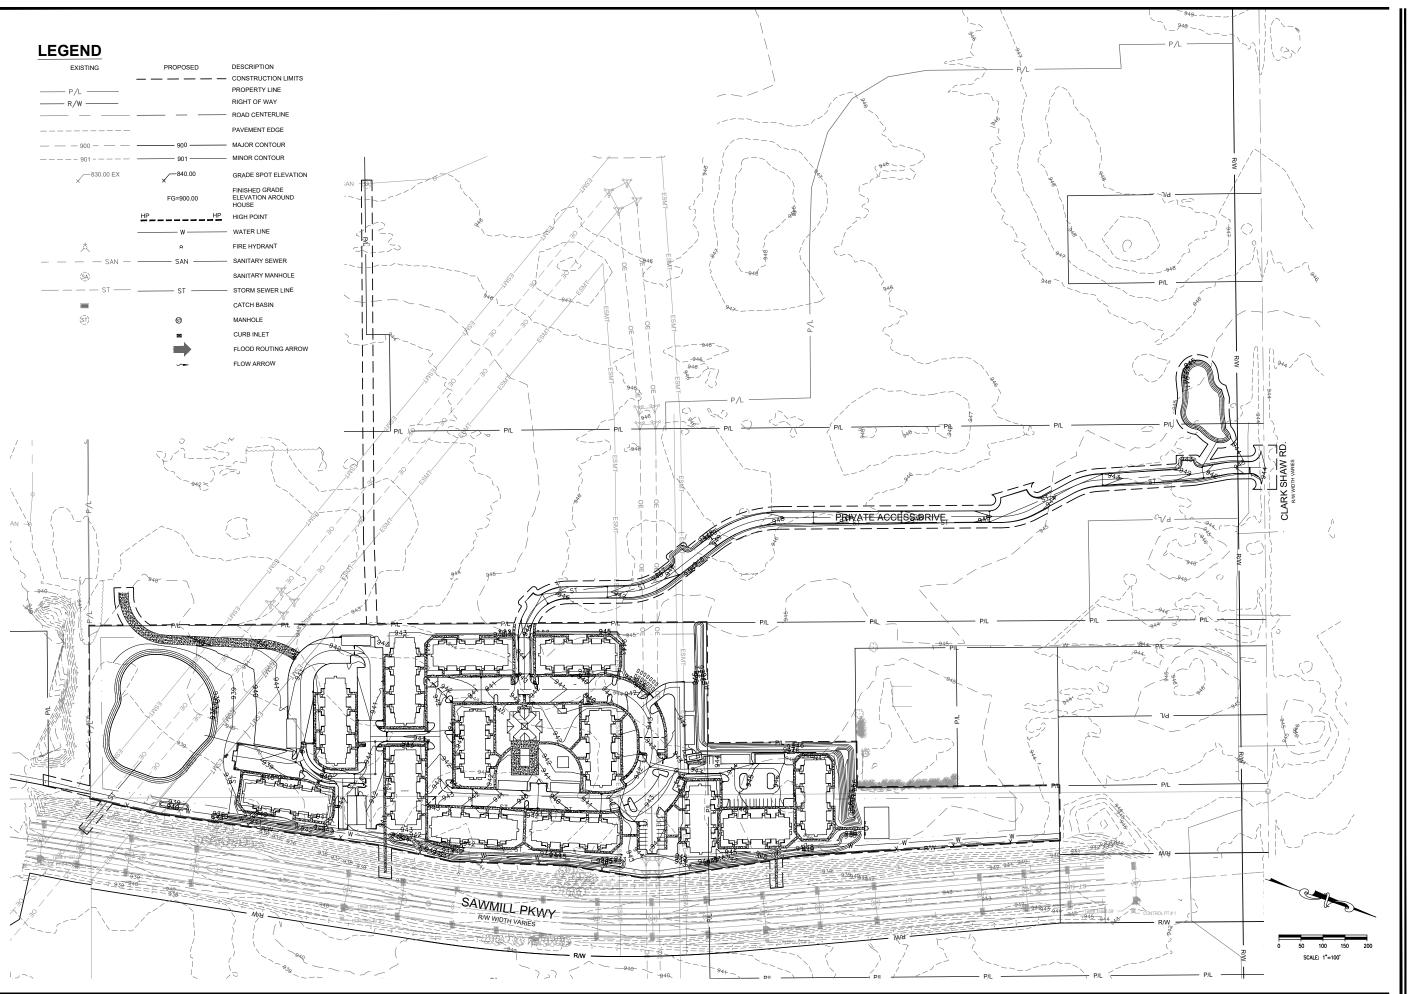
SHEET TITLE

SITE PLAN 7



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 SKETCH PLAN
 10/03/22

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PROJECT


ROSEWOOD VILLAGE

SWQ SAWMILL PKWY & CLARK-SHAW RD POWELL, OH 43065

SHEET TITLE

OVERALL GRADING PLAN

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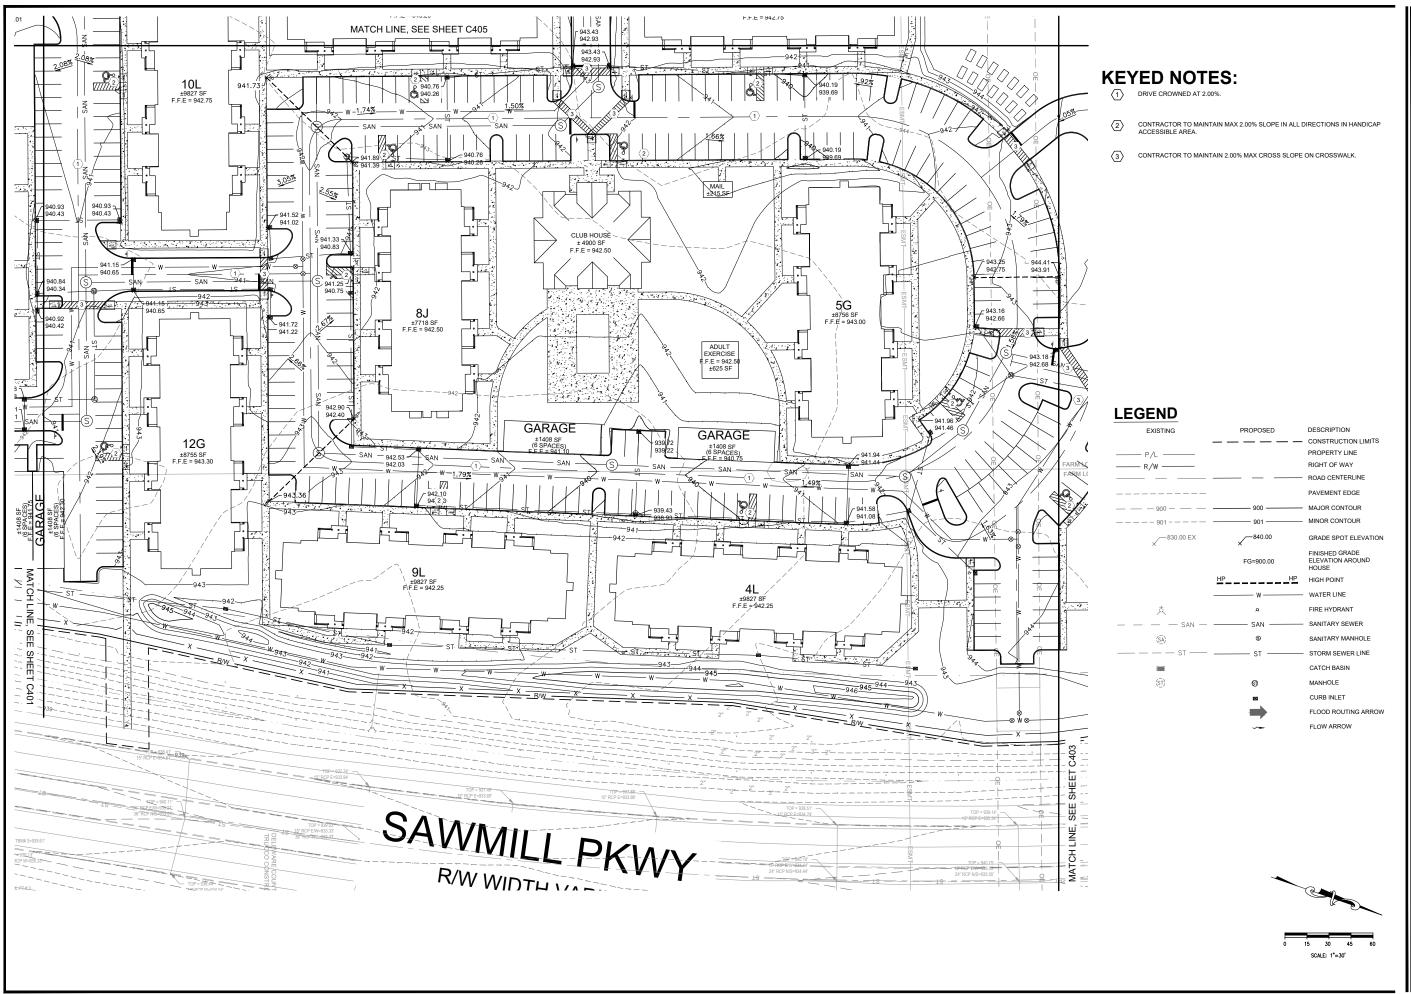
**ROSEWOOD** VILLAGE

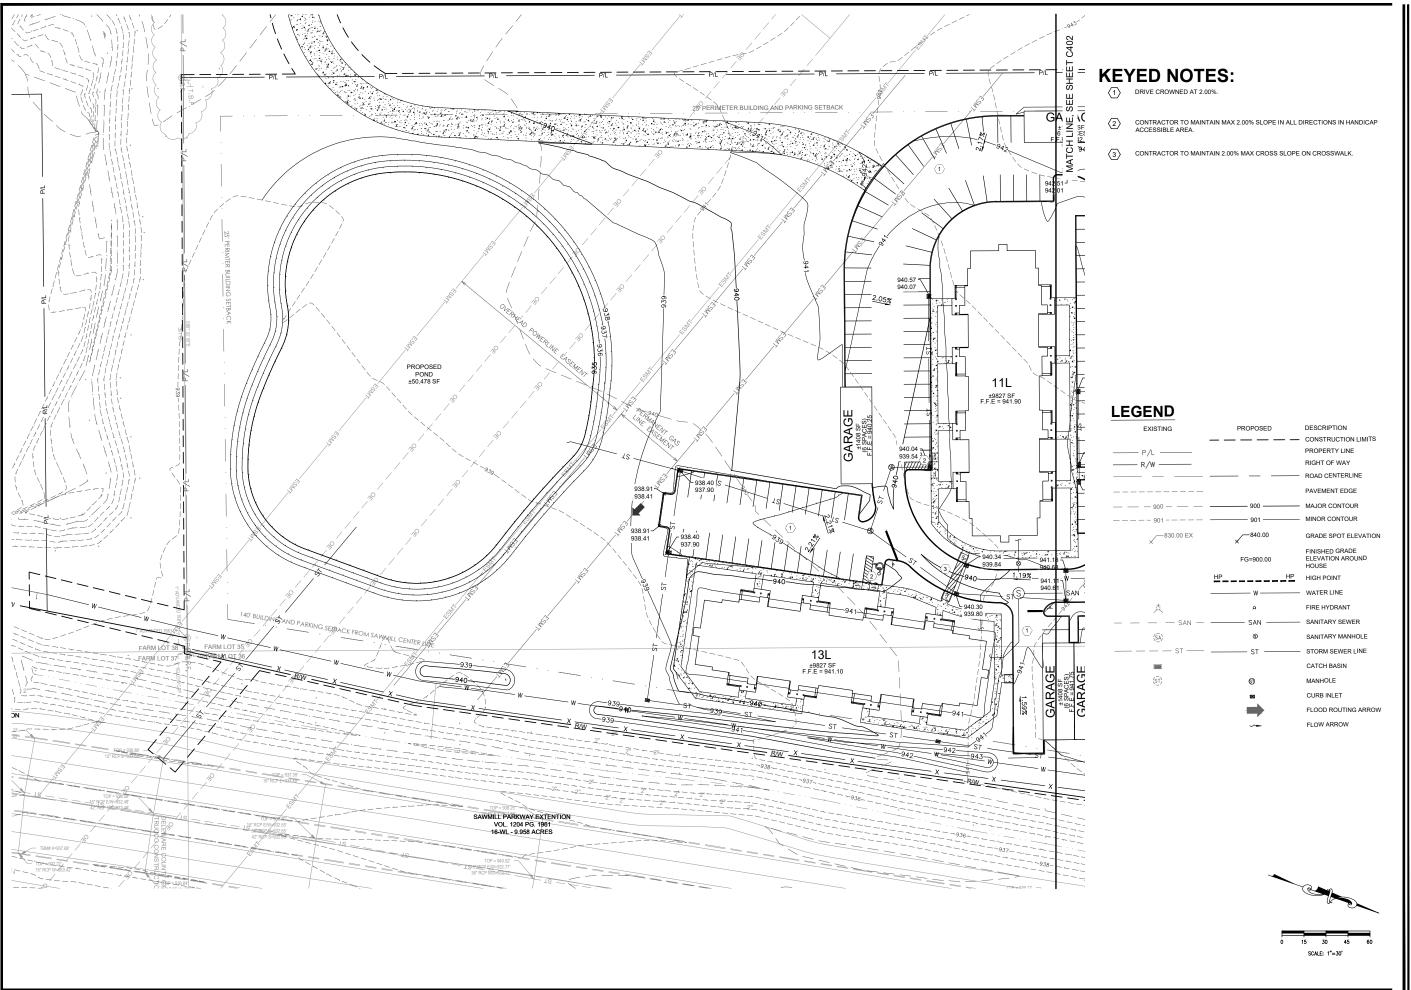SWQ SAWMILL PKWY & CLARK-SHAW RD POWELL, OH 43065

SHEET TITLE

**GRADING PLAN 1** 





CLARK-SHAW RD POWELL, OH 43065

PROJECT

**ROSEWOOD** 

VILLAGE

SHEET TITLE

**GRADING PLAN 2** 

SWQ SAWMILL PKWY &

REVISION/DATE/DESCRIPTION


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ROSEWOOD VILLAGE

SWQ SAWMILL PKWY & CLARK-SHAW RD POWELL, OH 43065

SHEET TITLE

GRADING PLAN 3

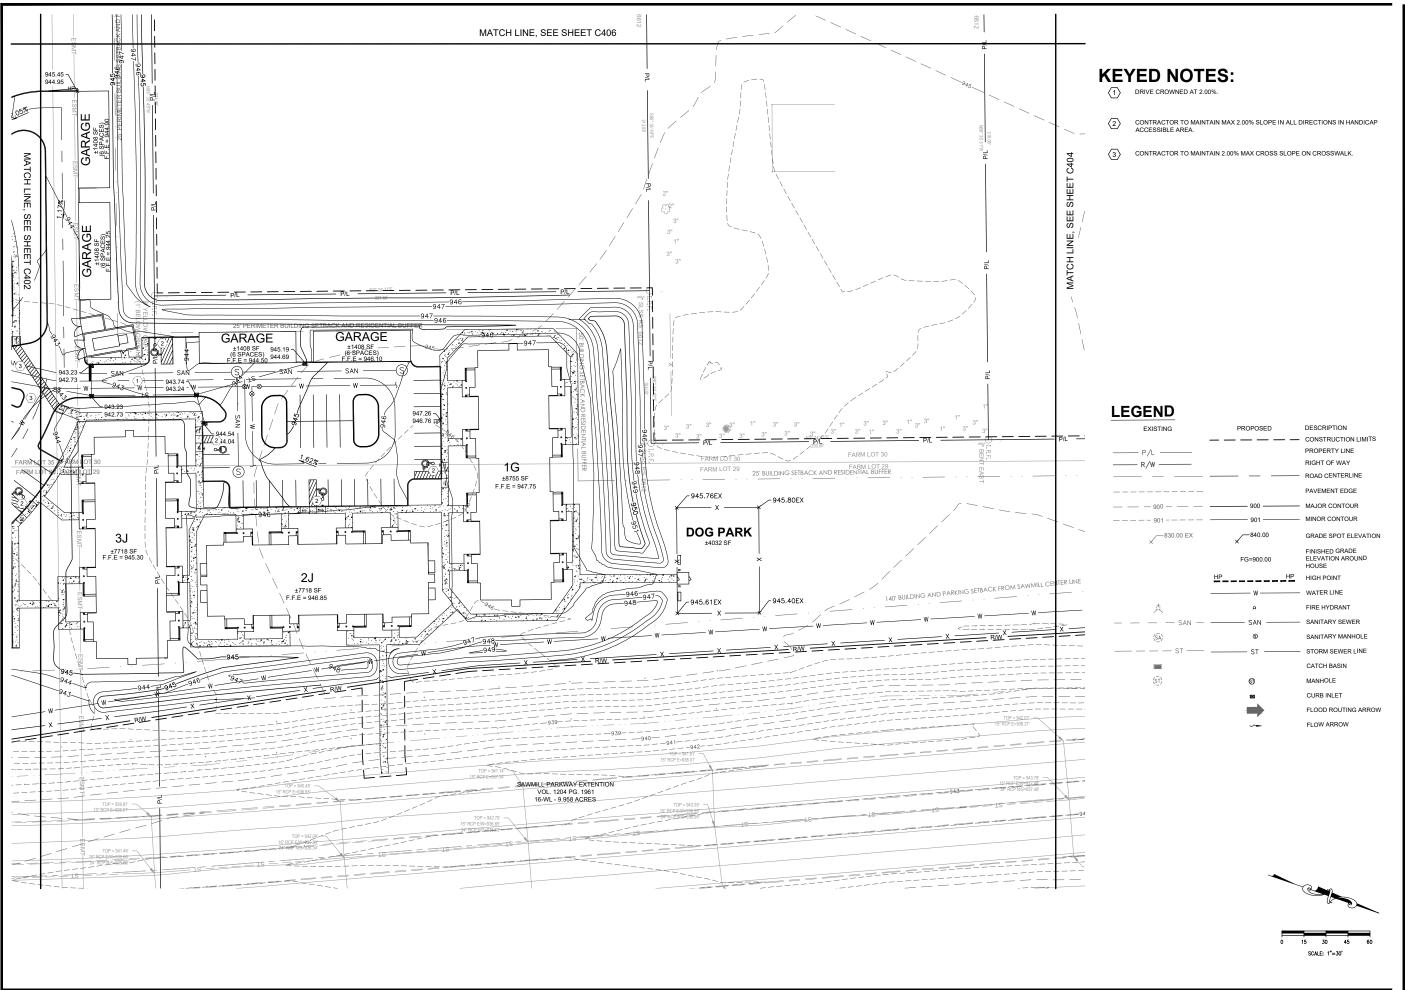

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DRAWING

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PROJECT

ROSEWOOD VILLAGE


SWQ SAWMILL PKWY & CLARK-SHAW RD POWELL, OH 43065

SHEET TITLE

GRADING PLAN 4



DRAWN BY: TDB
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PROJECT NO: 26607
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ROSEWOOD VILLAGE
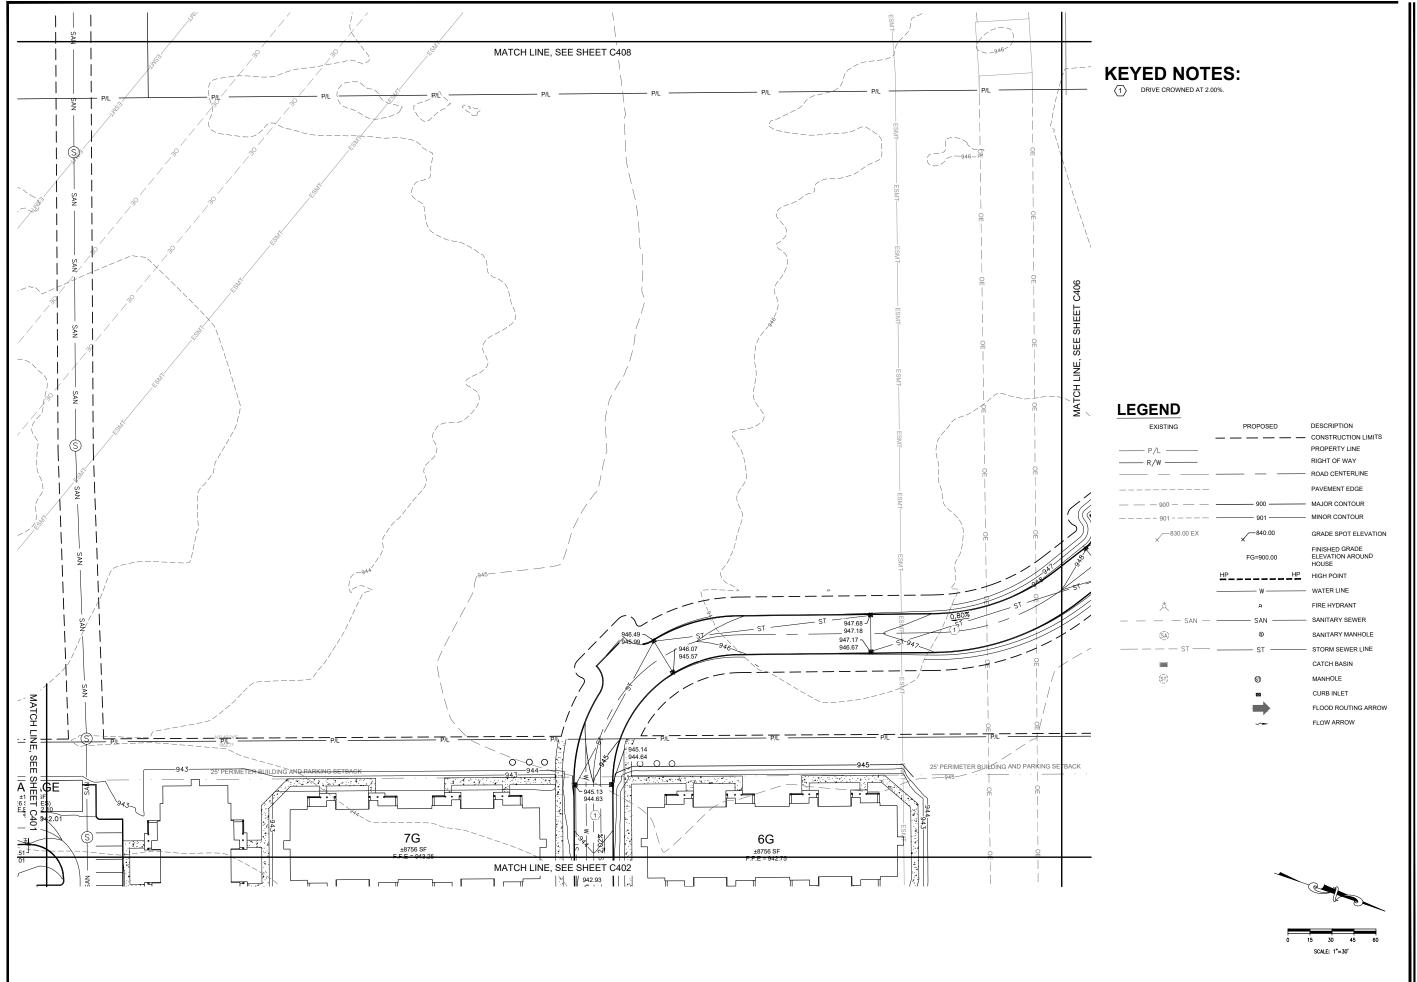
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SHEET TITLE

GRADING PLAN 5




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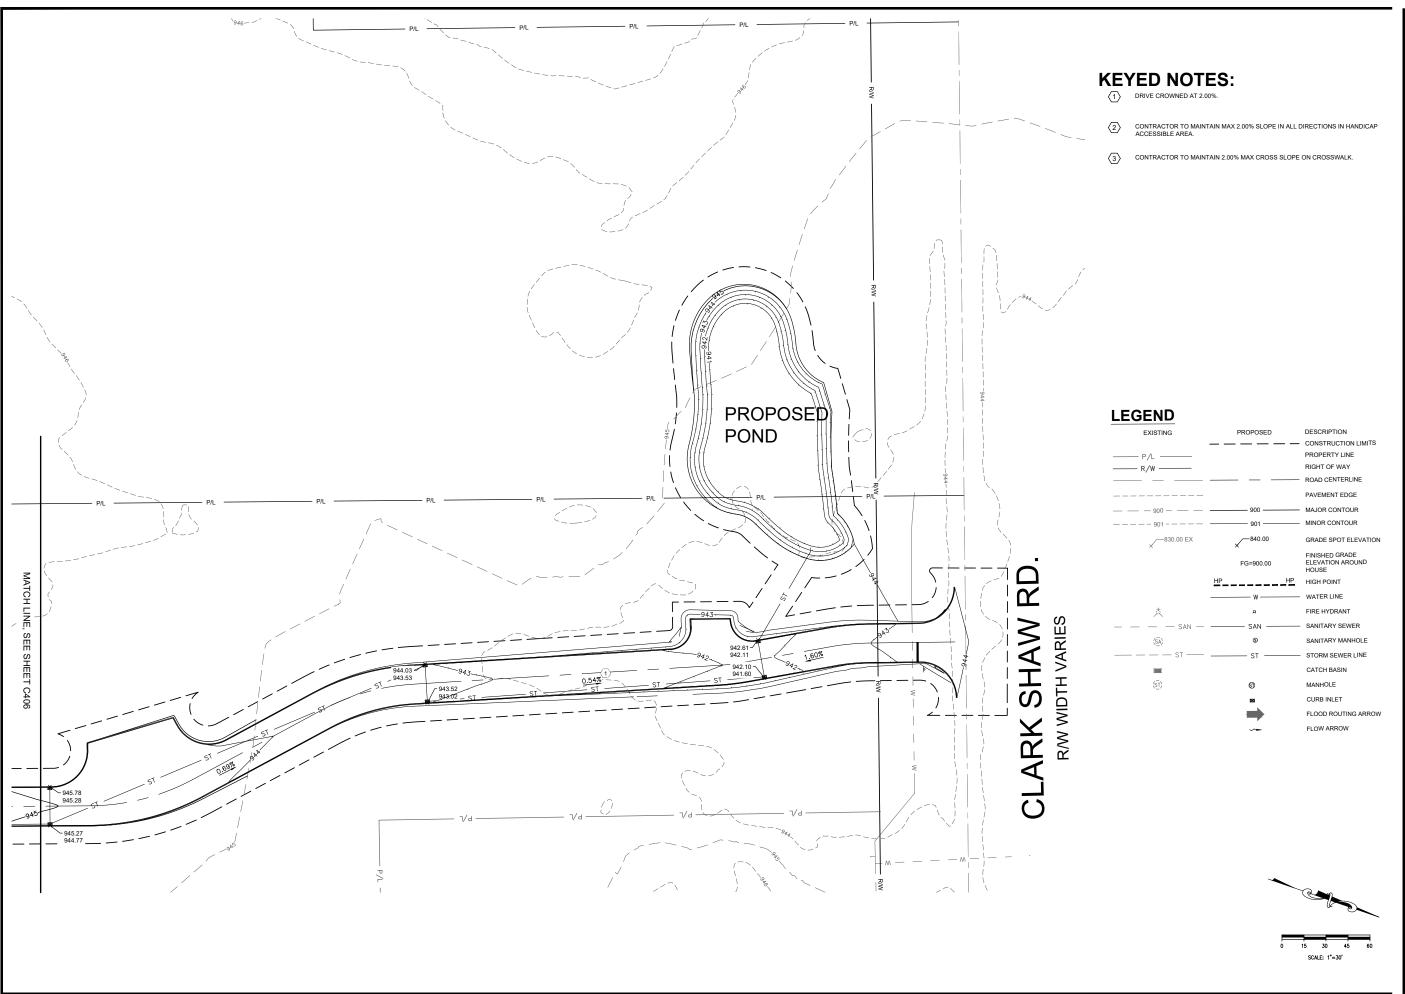
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SHEET TITLE

GRADING PLAN 6



DRAWN BY: TDB
CHECKED BY: PGD/KPD
PROJECT NO: 26607
DRAWING

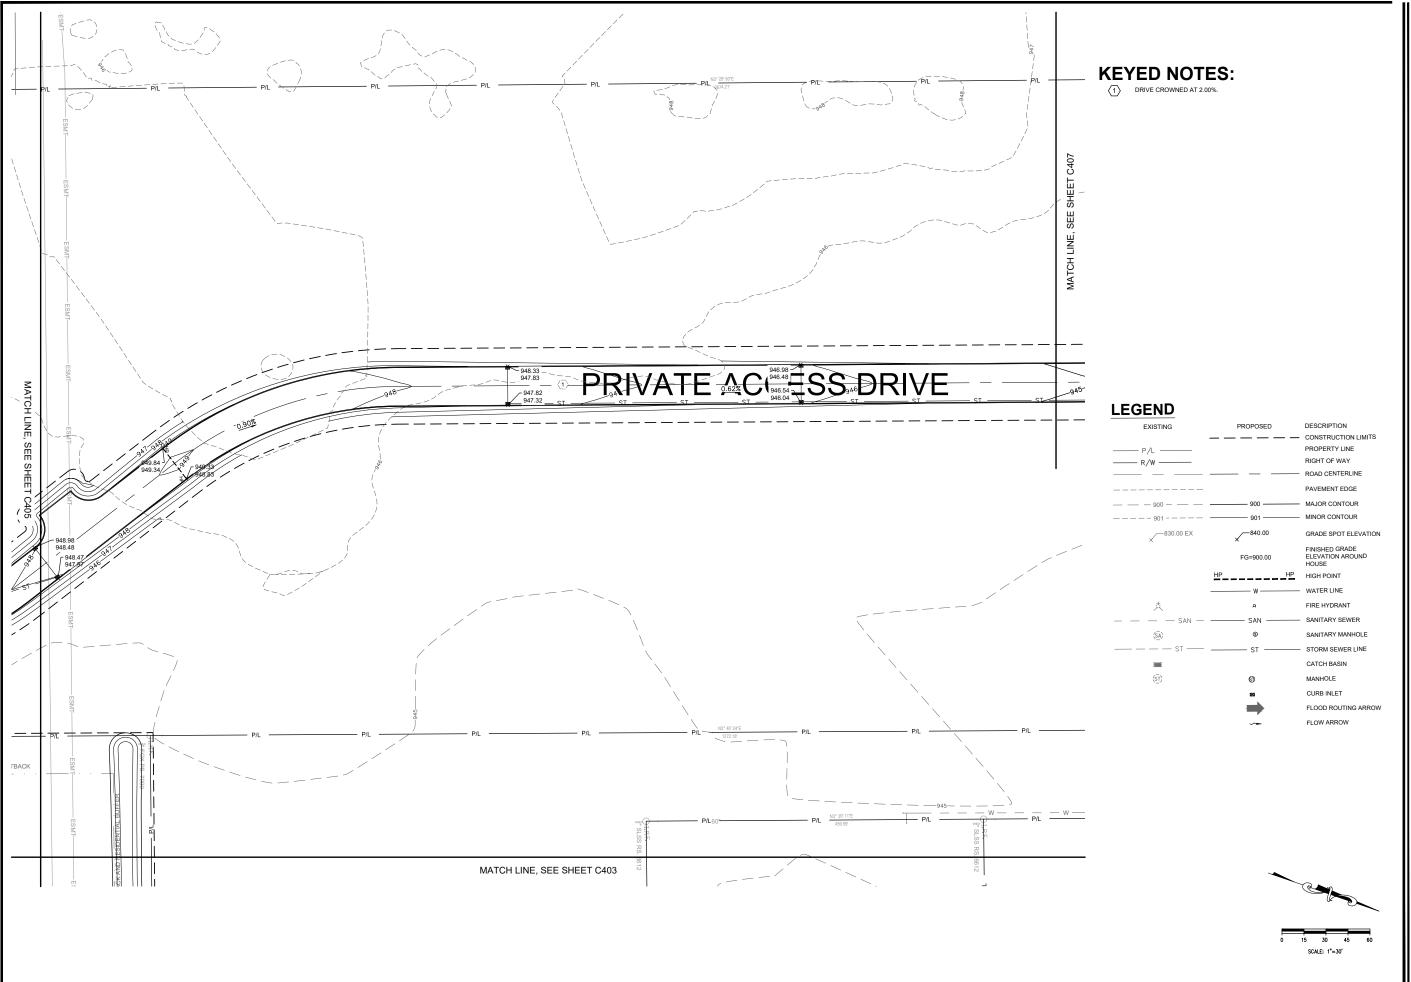

SKETCH PLAN 10/03/22 SUBMISSION 11/23/22

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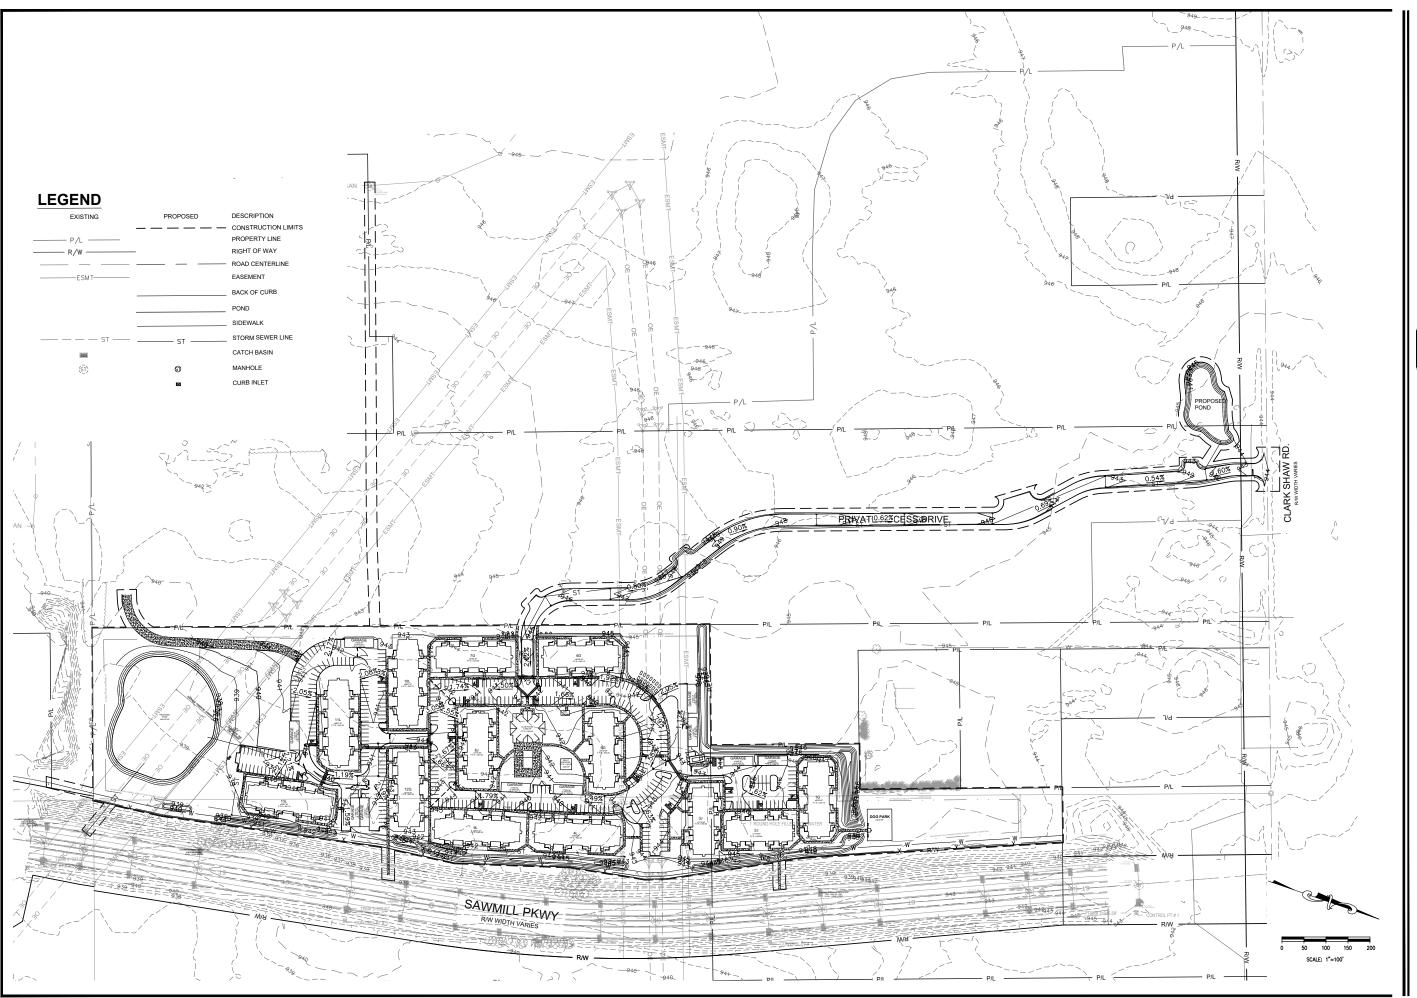
SHEET TITLE

GRADING PLAN 7



DRAWN BY: TDB
CHECKED BY: PGD/KPD
PROJECT NO: 26607
DRAWING

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 SKETCH PLAN
 10/03/22

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SHEET TITLE


OVERALL DRAINAGE PLAN

 DRAWN BY:
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 PROJECT NO:
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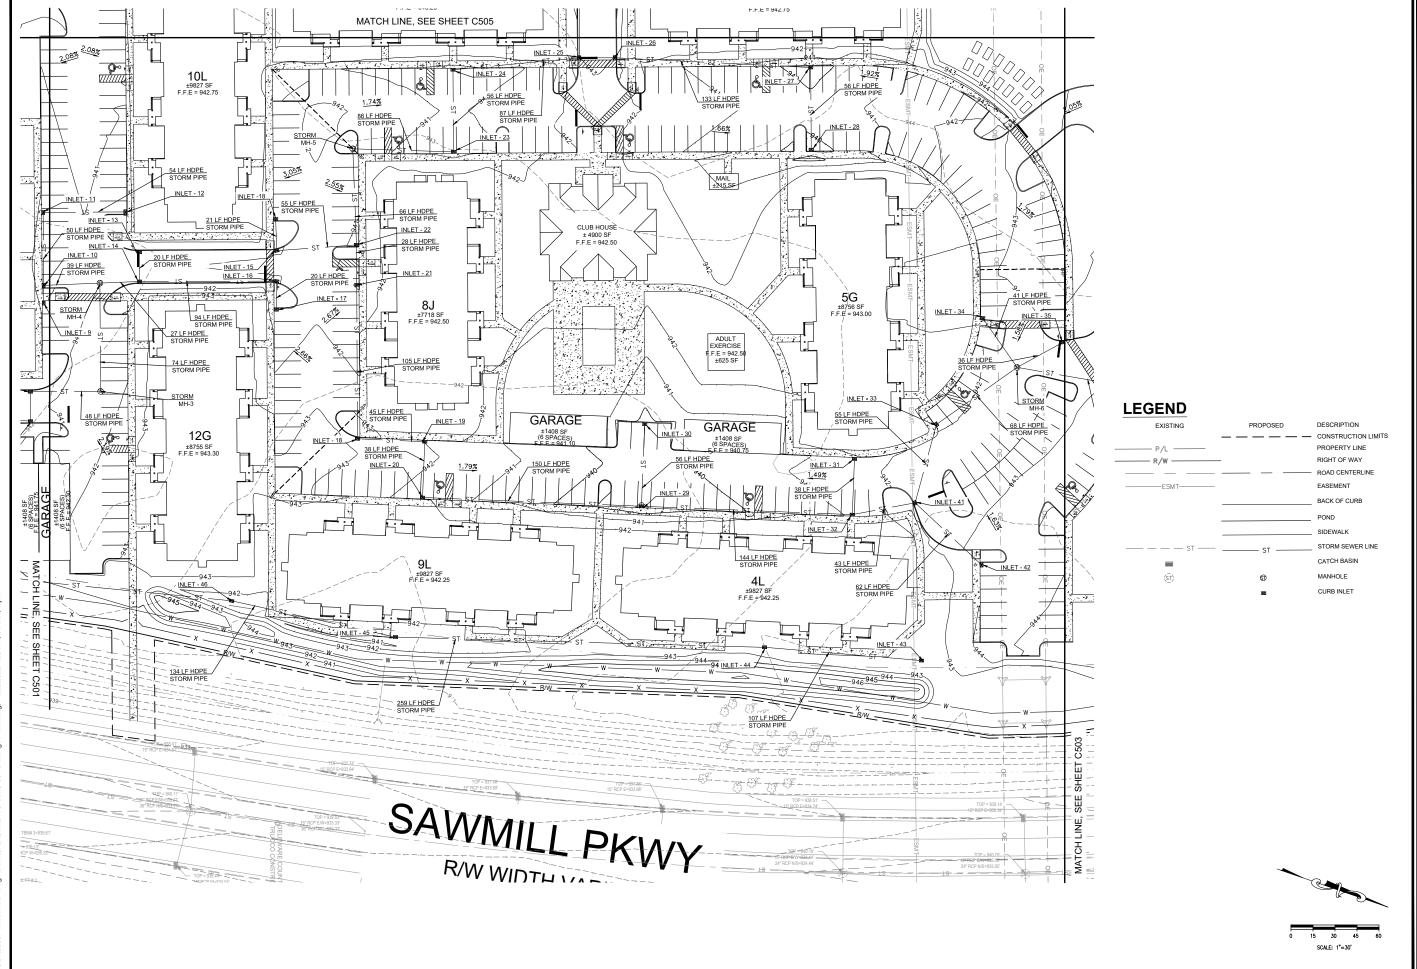
SHEET TITLE

DRAINAGE PLAN 1



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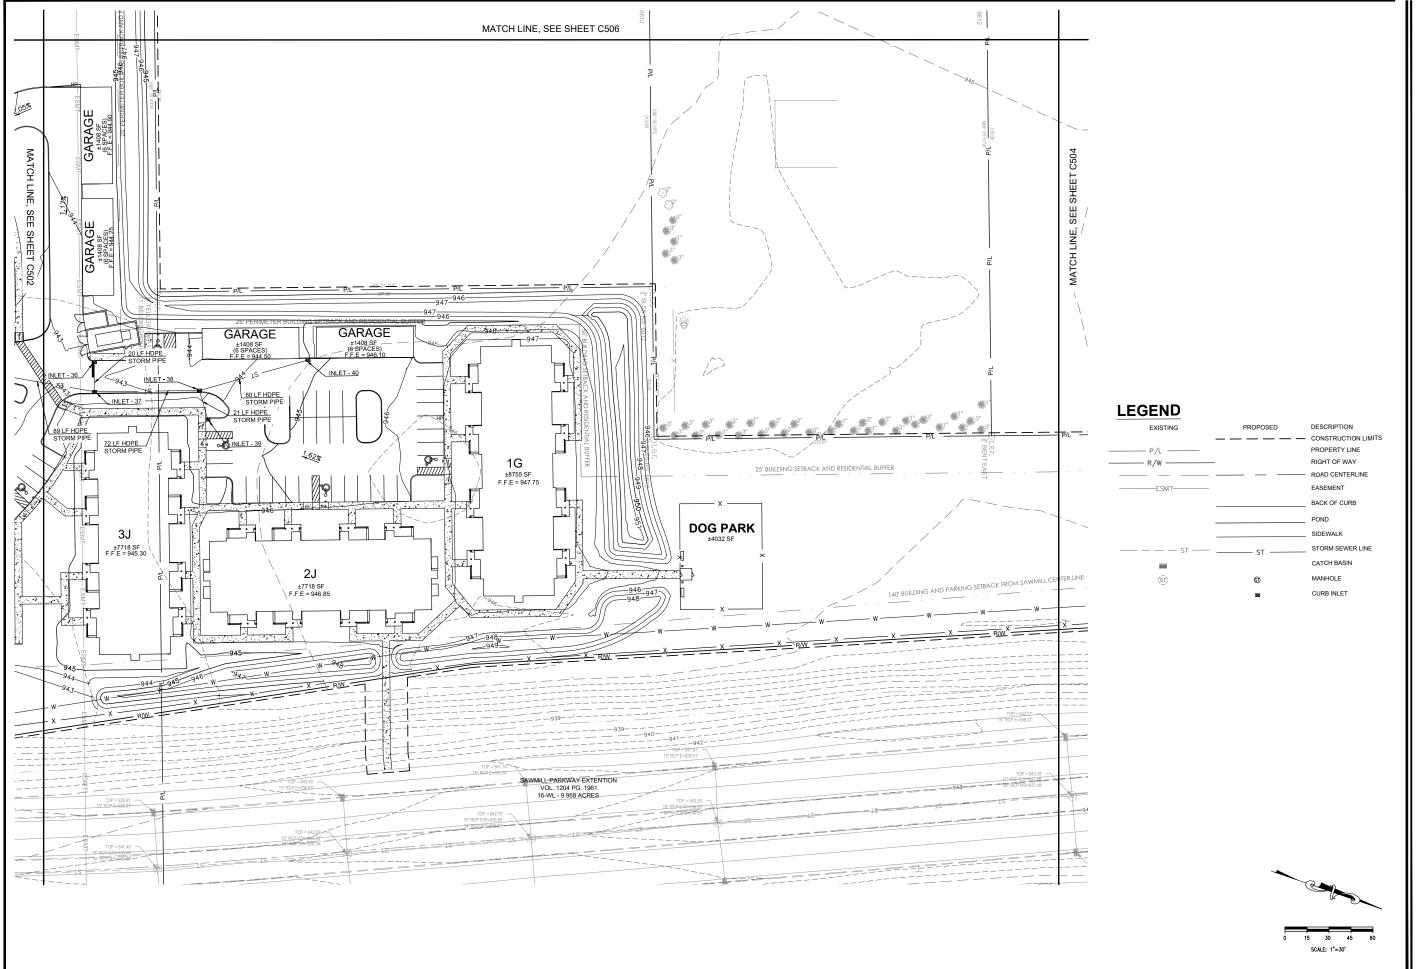
SWQ SAWMILL PKWY & CLARK-SHAW RD POWELL, OH 43065

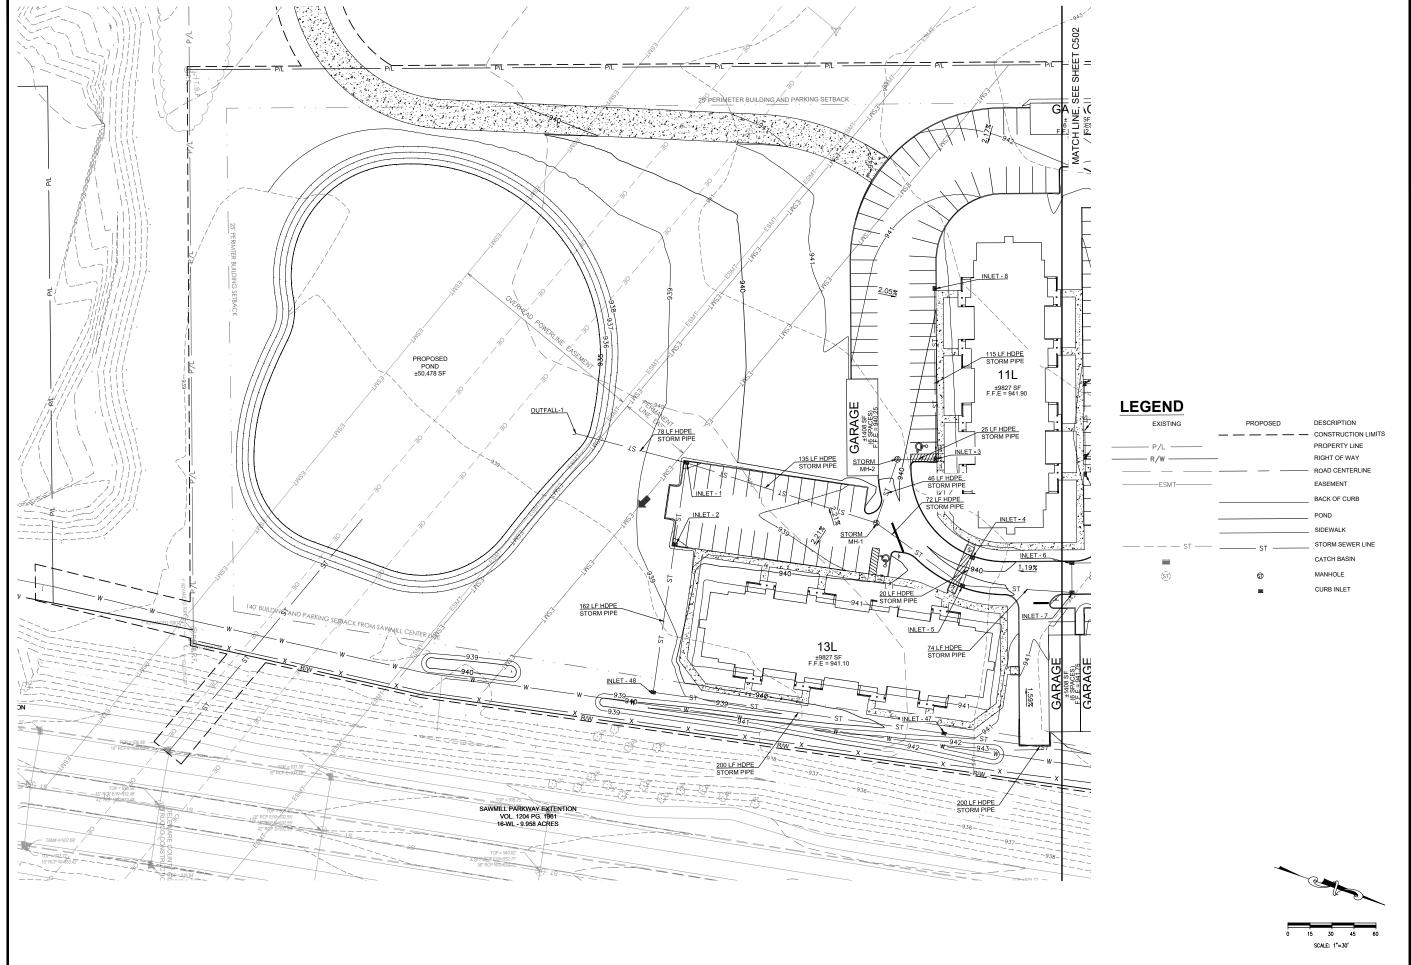SHEET TITLE

DRAINAGE PLAN 2



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SHEET TITLE

DRAINAGE PLAN 3



TDB PGD/KPD CHECKED BY: 26607 DRAWING



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PROJECT

ROSEWOOD VILLAGE

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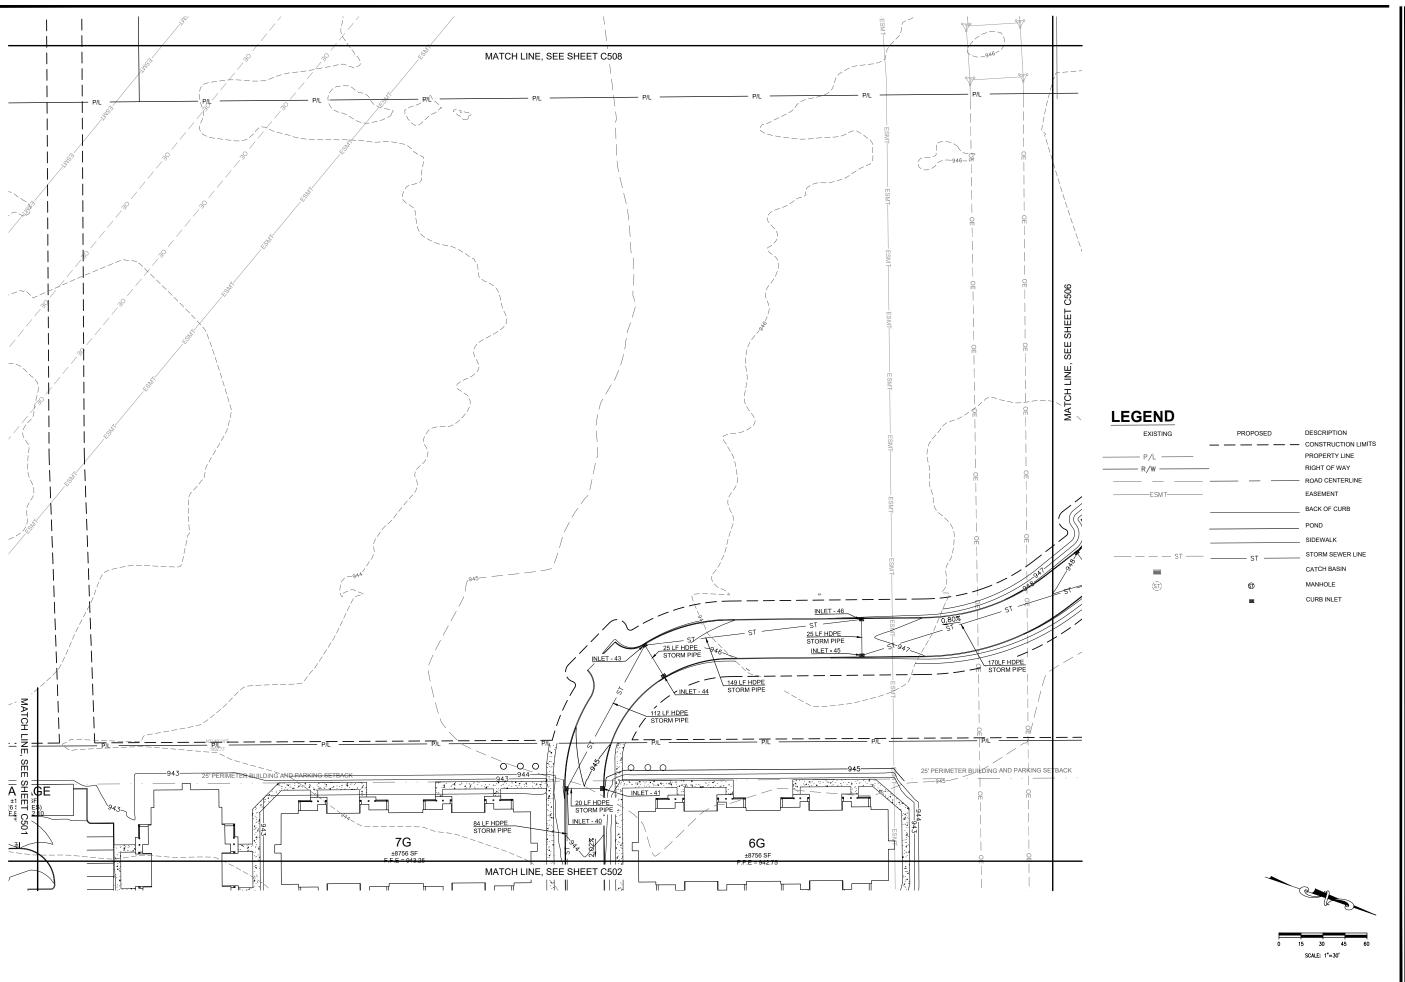
SHEET TITLE

DRAINAGE PLAN 4



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CHECKED BY: PGD/KPD
PROJECT NO: 26607
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SHEET TITLE

DRAINAGE PLAN 5




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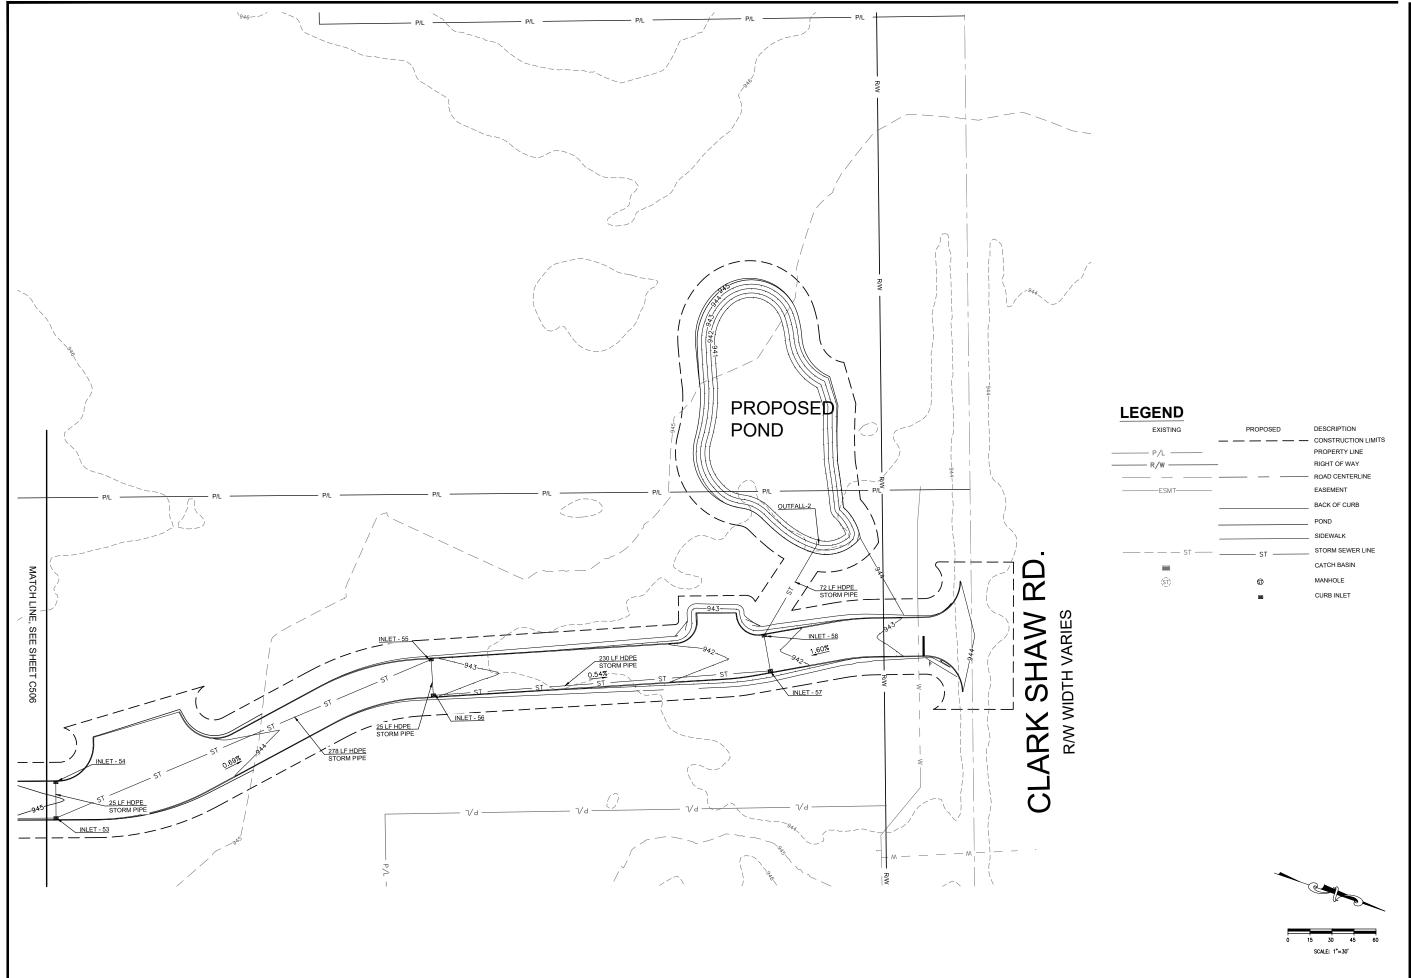
SWQ SAWMILL PKWY & CLARK-SHAW RD POWELL, OH 43065

SHEET TITLE

DRAINAGE PLAN 6

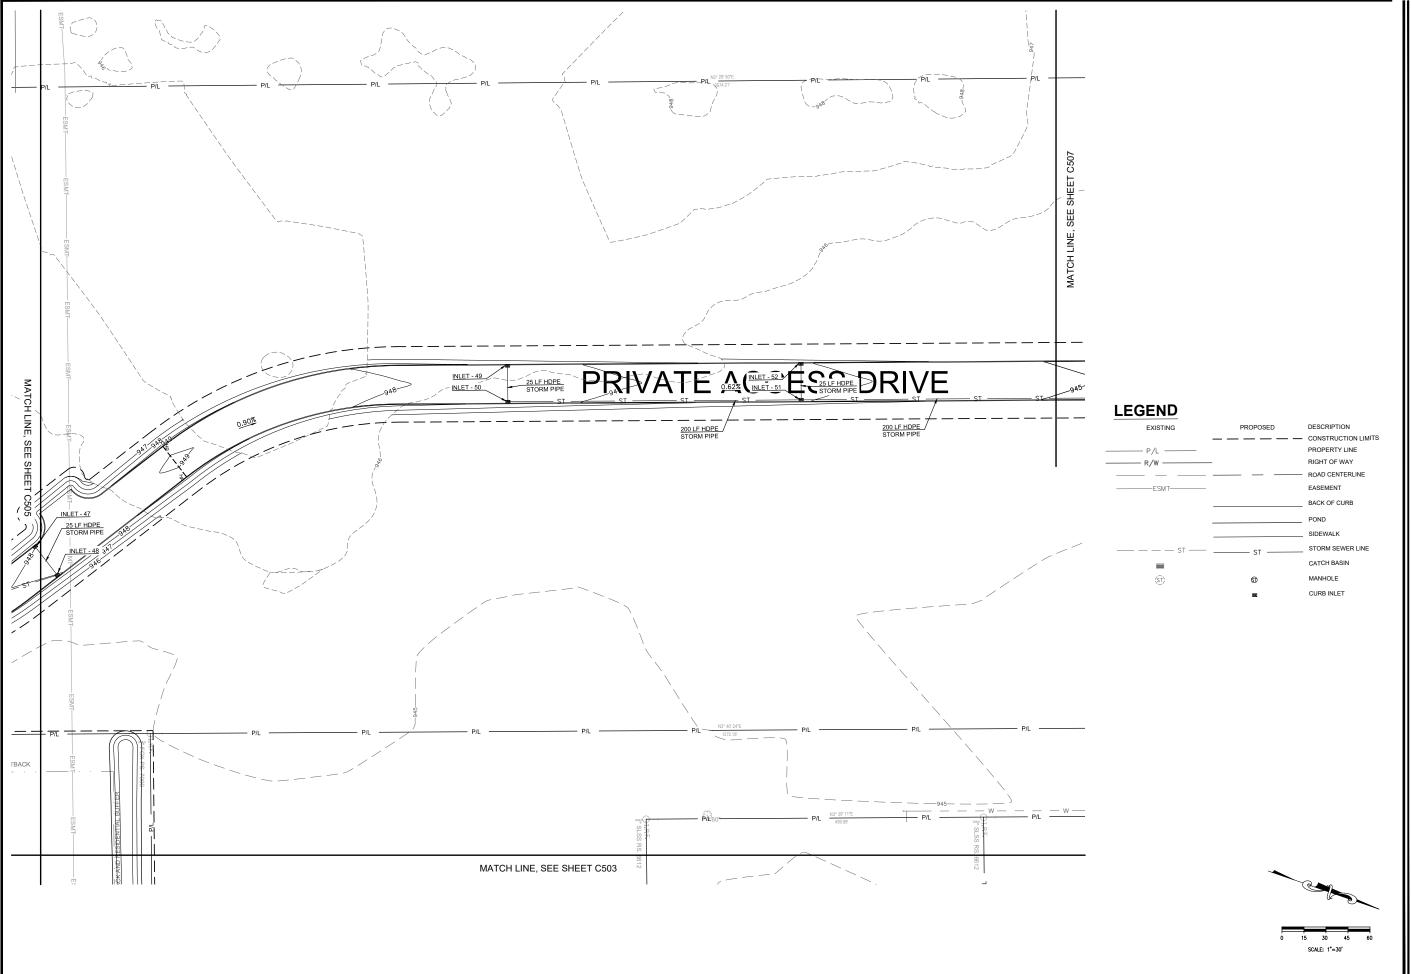

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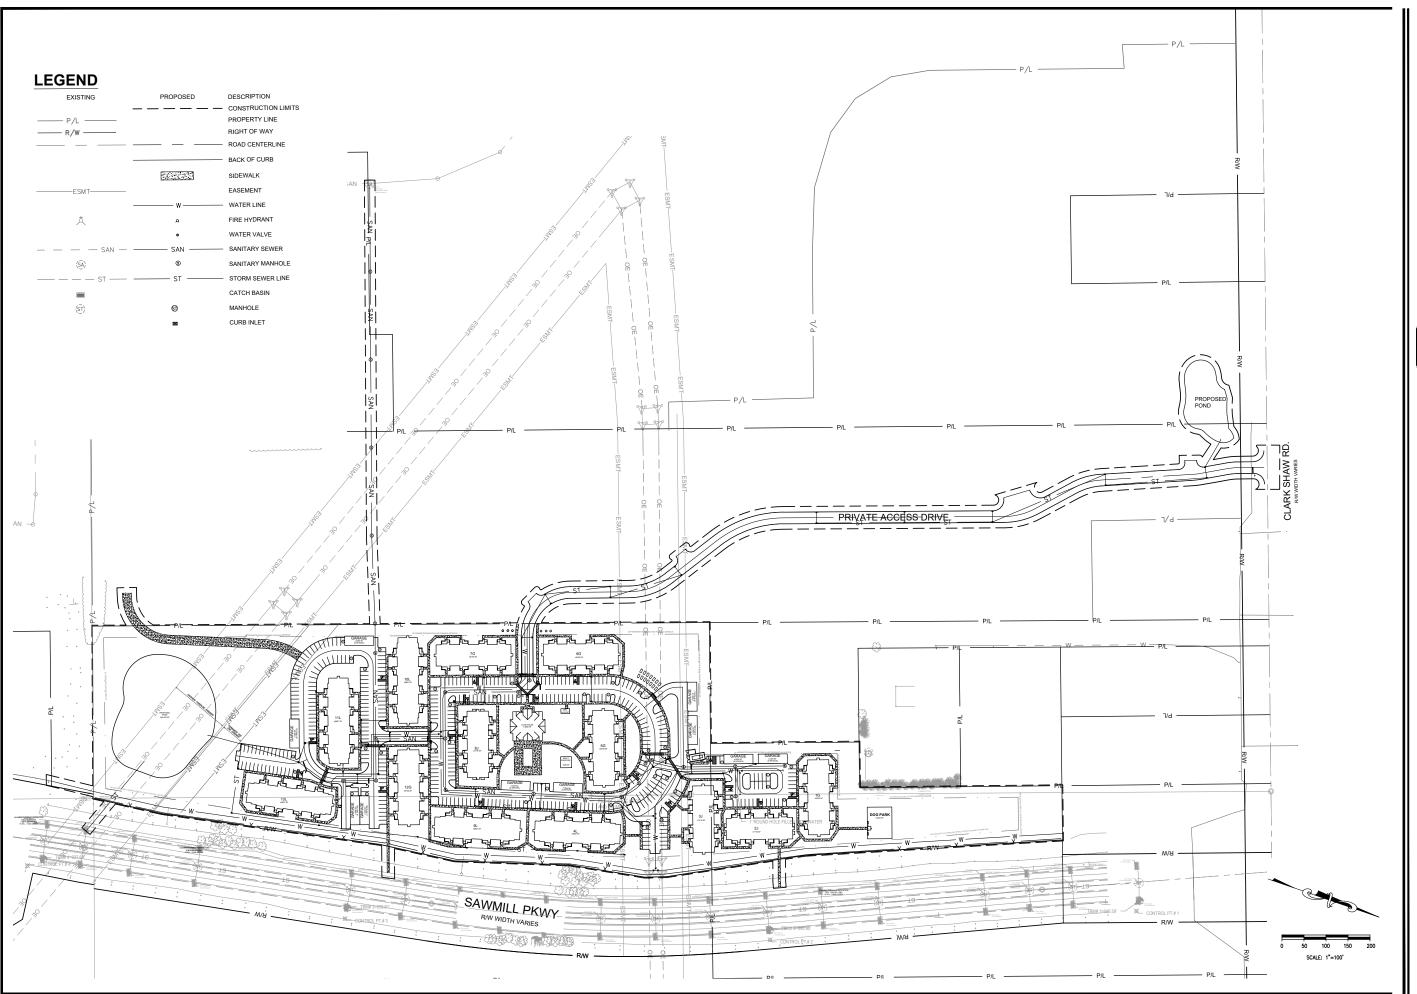
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SHEET TITLE

DRAINAGE PLAN 7



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 SKETCH PLAN
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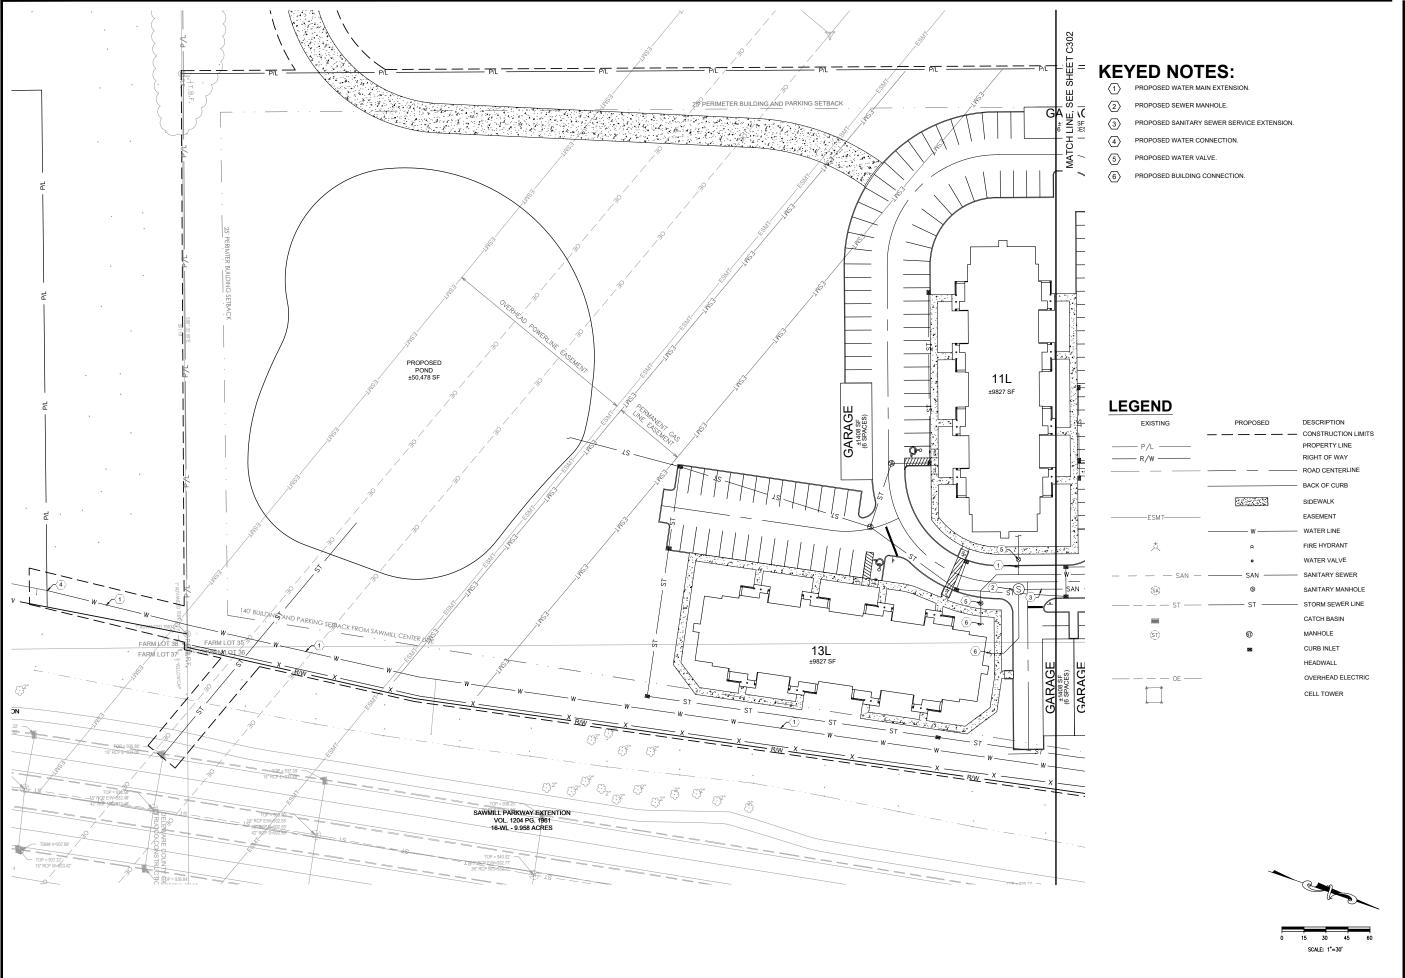
OVERALL UTILITY PLAN

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SHEET TITLE

UTILITY PLAN 1




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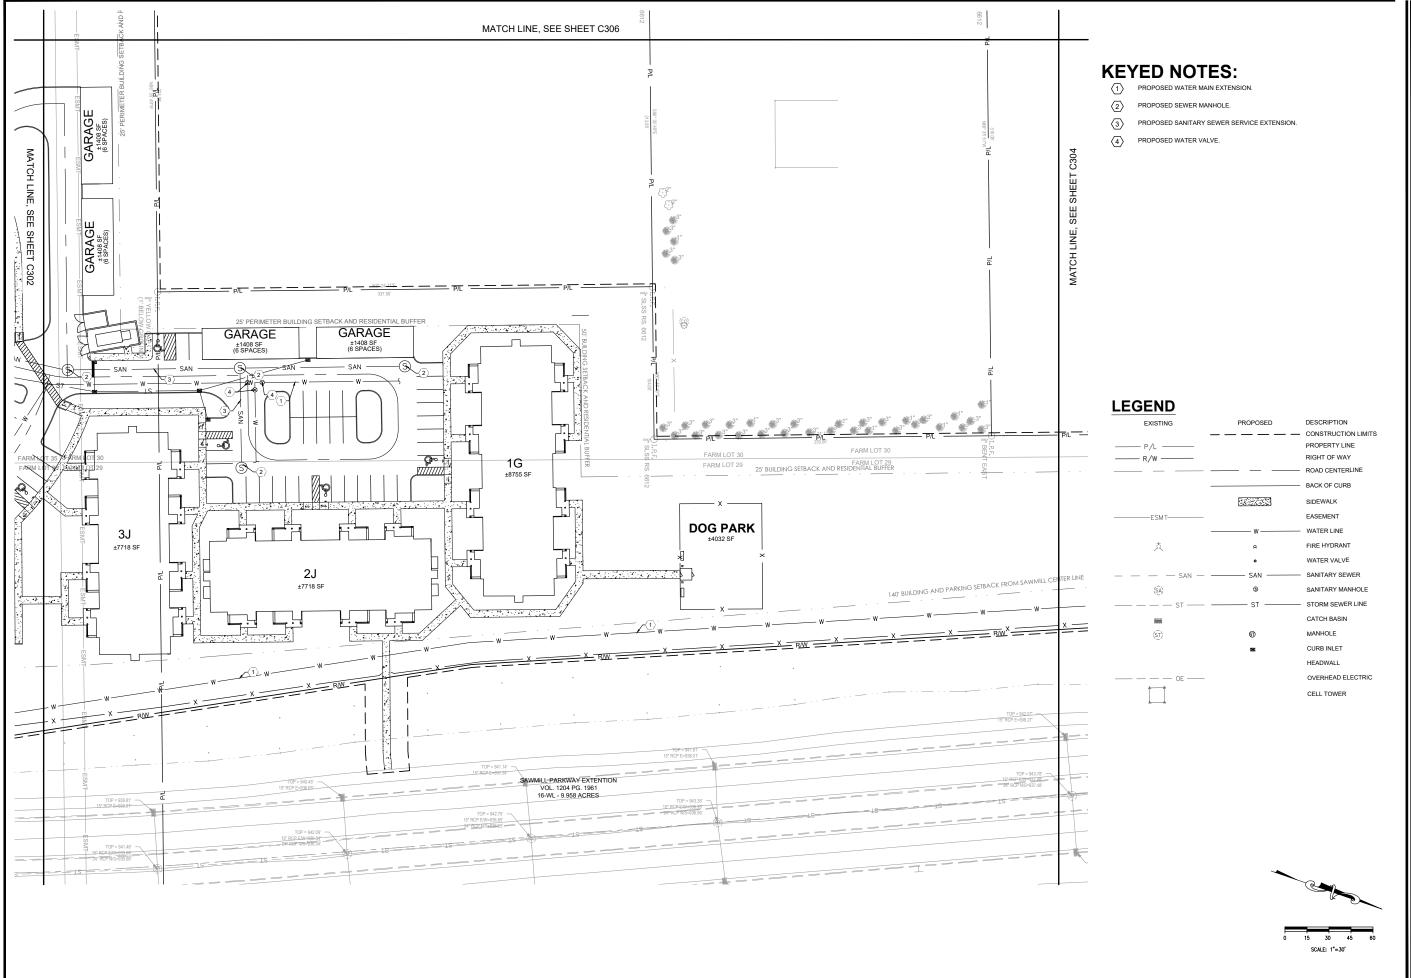
SHEET TITLE

**UTILITY PLAN 2** 



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SHEET TITLE

UTILITY PLAN 3

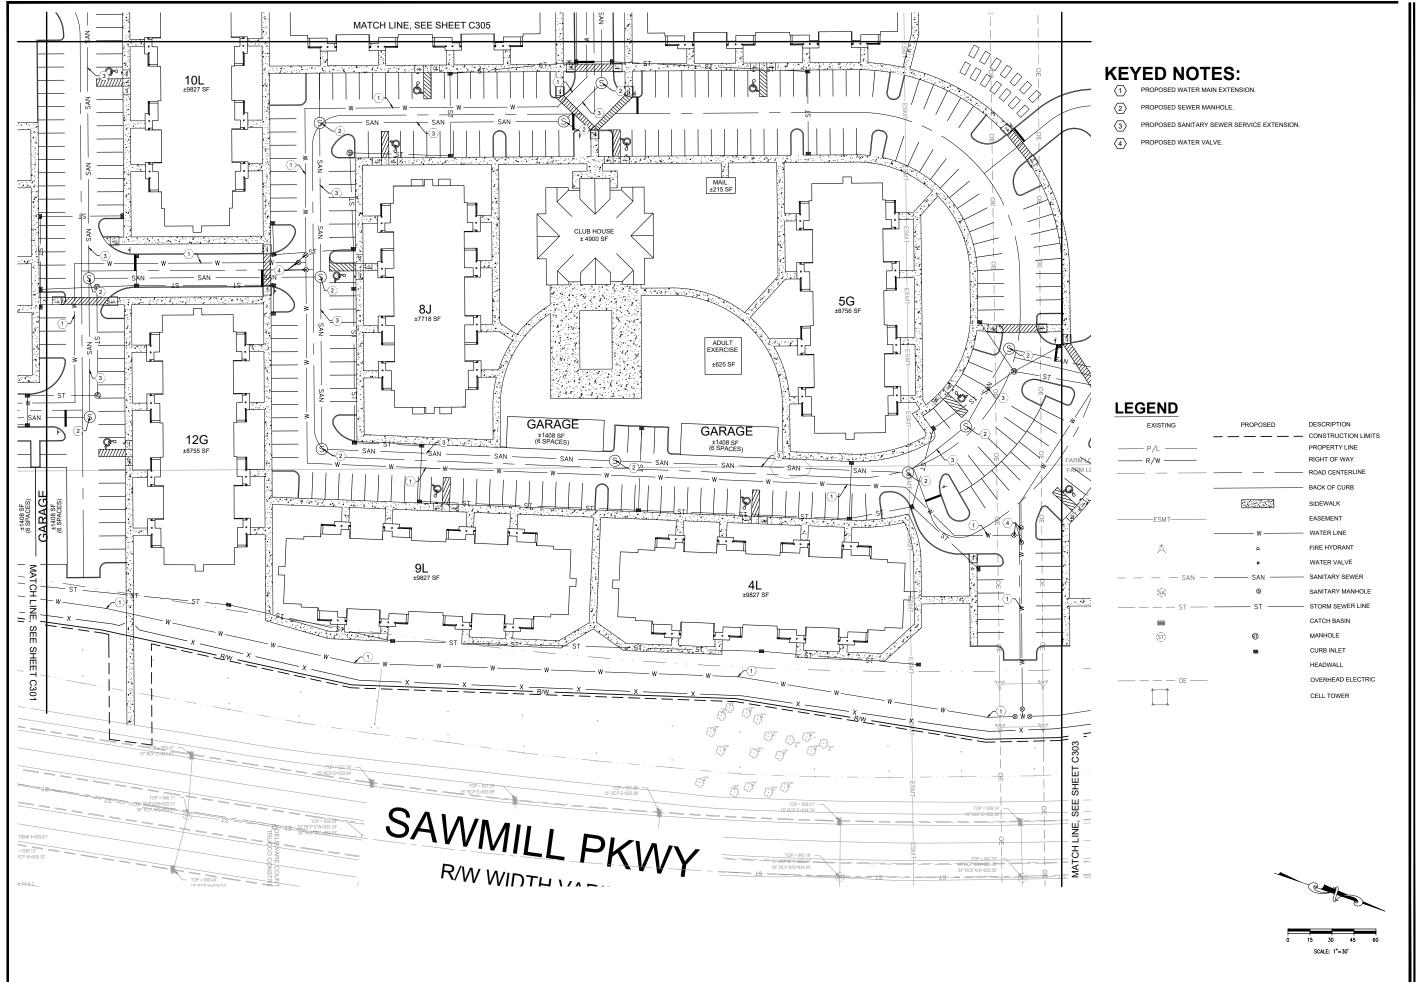

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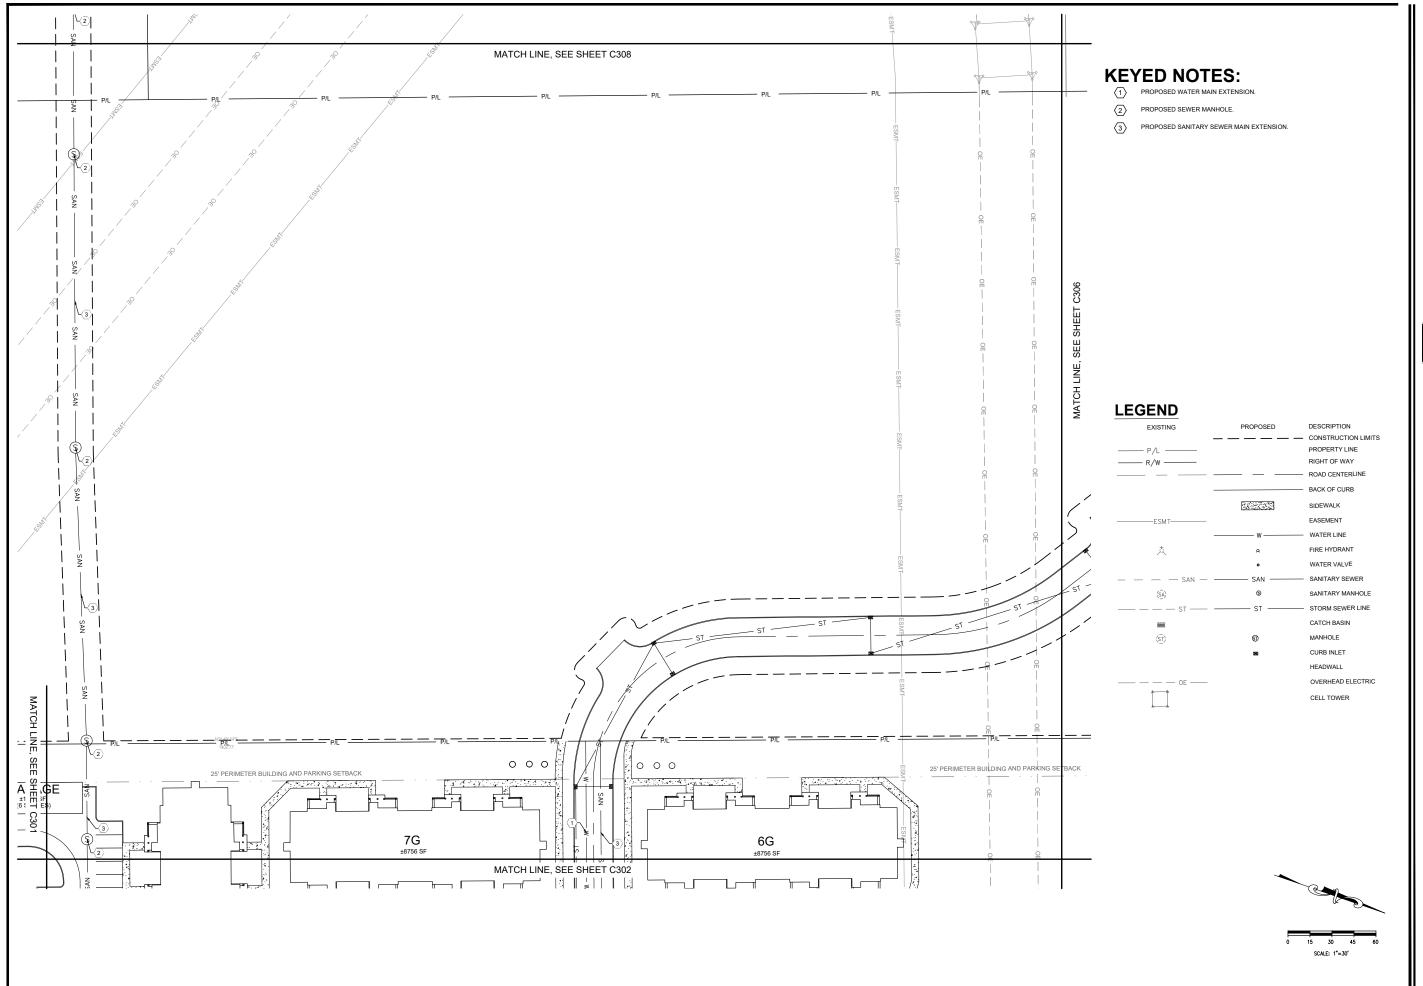
SWQ SAWMILL PKWY & CLARK-SHAW RD POWELL, OH 43065

SHEET TITLE

**UTILITY PLAN 4** 



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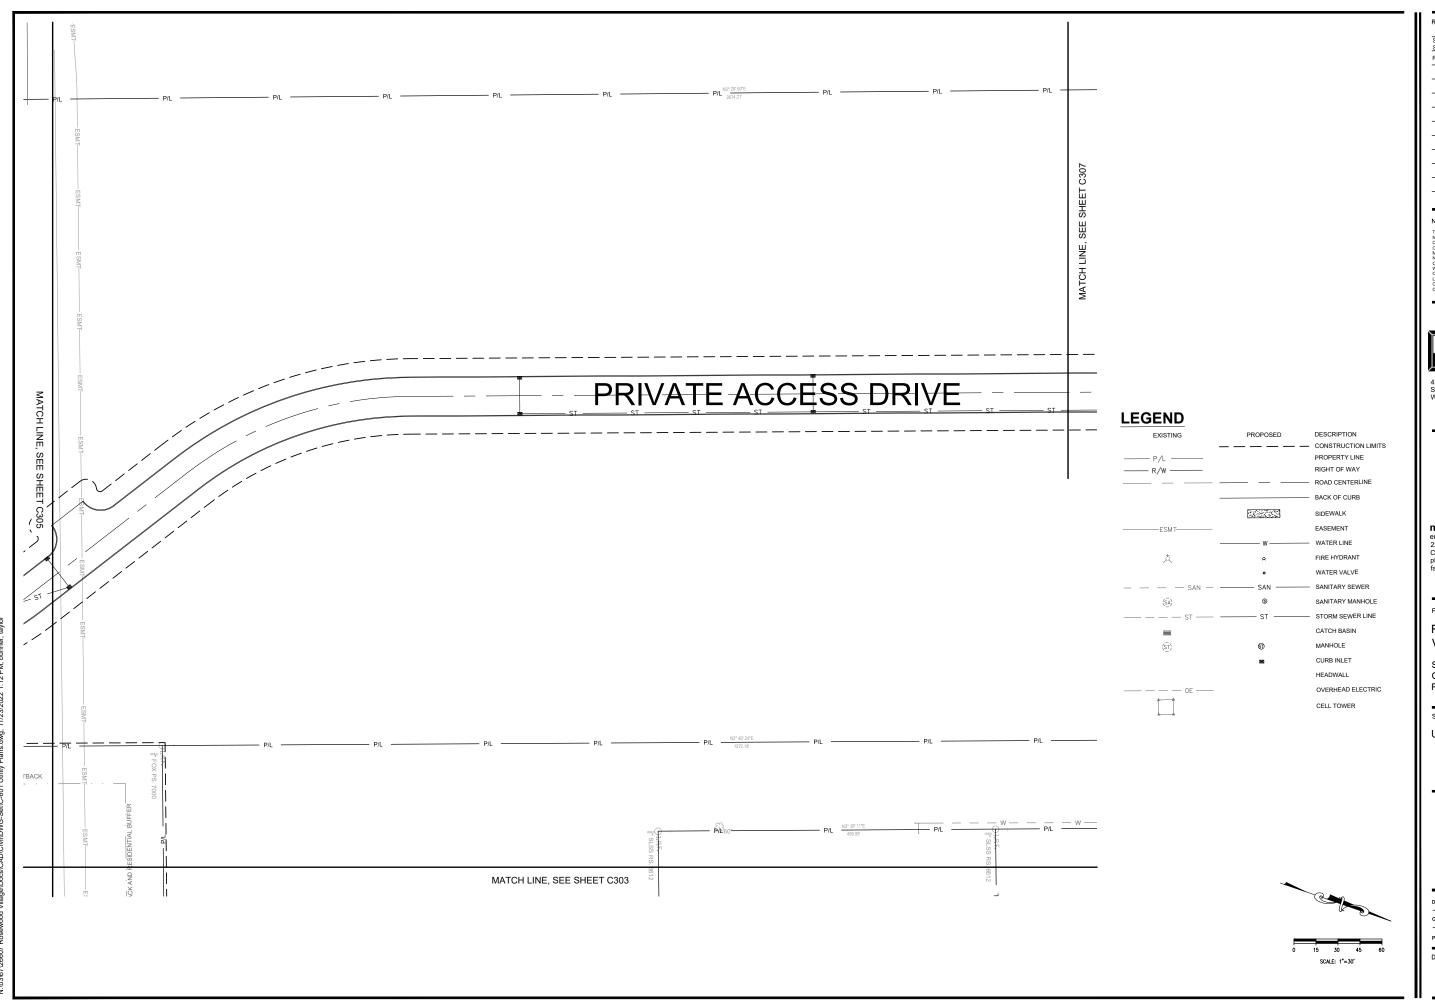
SHEET TITLE

UTILITY PLAN 5



DRAWN BY: TDB
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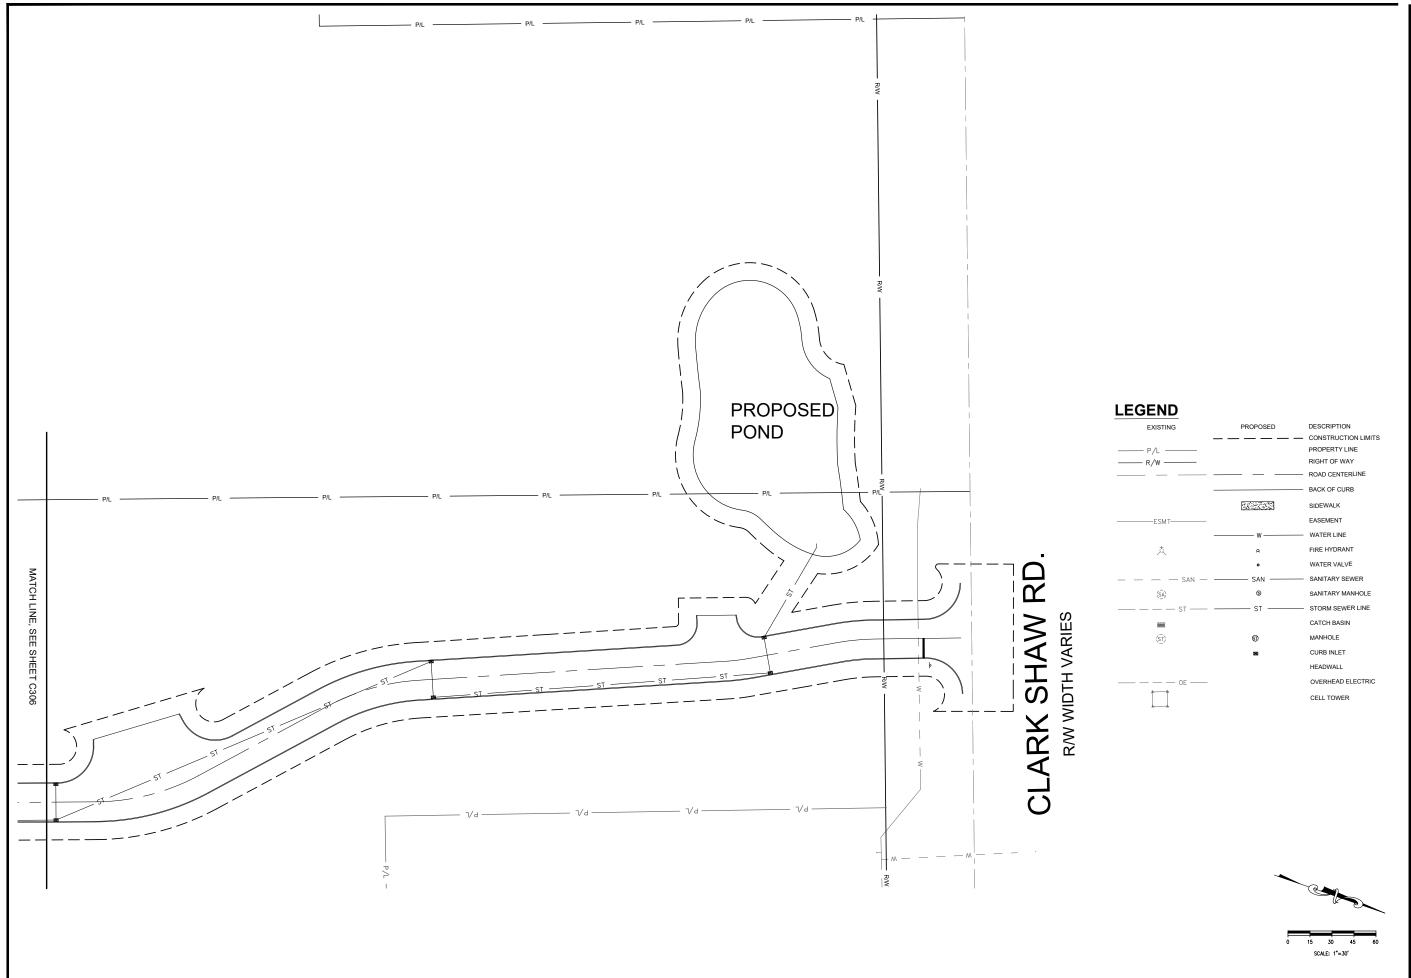
SHEET TITLE

**UTILITY PLAN 6** 



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PROJECT NO:	2660

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SKETCH PLAN

SUBMISSION	10/00/22
RPC SUBMISSION	11/23/22

# NOTICE



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PROJECT

ROSEWOOD VILLAGE

SWQ SAWMILL PKWY & CLARK-SHAW RD POWELL, OH 43065

SHEET TITLE

**UTILITY PLAN 7** 



DRAWN BY:	TDB
CHECKED BY:	PGD/KPD
PROJECT NO:	26607
DRAWING	